Attachment 1- Revised Development Plans



SITE STATISTICS

ZONING CATOGORY: DOWNTOWN CORE LOT AREA: 9886.4 m² (2.44 ACRE) NET LOT AREA: 9678.5 m² (2.39 ACRE)

			.	♦ CE
	PERMITTED / REQUIRED	PROPOSED / PROVIDED		ф _F
BUILDING AREA		1,337.48 M ² (14,396 SF)		(xx
GROSS FLOOR AREA		6,492.16 M ² (69,881 SF)		
LOT COVERAGE	75% MAX.	13.8%		
LANDSCAPE AREA	30% MIN.	45.77%		
BUILDING HEIGHT	4 STOREYS MAX.	5 STOREYS (18.17m)		
LOT FRONTAGE	25m MIN.	69.32m		
LOT AREA	1,000m² MIN.	9,678.5m ²		
FRONT YARD	0m MIN.	1.22m		
INTERIOR YARD	1.2m MIN.	5.96m / 12.08m		PR 2/24
REAR YARD	7.5m MIN.	48.56 m	<i>'</i>	EPT. 1/22 IAR 22/22
AMENITY SPACE	1BD: 14X5=70 M ² 1BD+DEN & 2BD: 56X10=560 M ² TOTAL: 630 m ²	249 m² (INDOOR) 397 m² (OUTDOOR) TOTAL: 646 m²	6 N 5 A 4 N	OV 23/20 OV 23/20 UG 26/20 IAY 06/20 PR. 08/20
RESIDENTIAL UNITS		1-BEDROOM: 14 UNITS 1-BEDROOM + DEN: 33 UNITS 2-BEDROOM: 23 UNITS TOTAL: 70 UNITS	2 A	UG. 08/18 UG. 03/18 Date:
DENSITY	74 UNITS/HECTARE MAX.	72 UNITS/HECTARE		
LOCKERS		70		W
PARKING	RESIDENCE: 88 SPACES (1.25 SPACE/UNIT)	88 SPACES		VV
	VISITOR: 11 SPACES (0.15 SPACE/UNIT)	11 SPACES		
	TOTAL 99 SPACES	99 SPACES		
	BARRIER-FREE: 5 SPACES	5 SPACES		
BICYCLE PARKING	18 SPACES (0.25 SPACE/UNIT)	18 SPACES		



FIRE ROUTE SIGN

FIRE DEPARTMENT CONNECTION

MEN DOOR (ENTRANCES & EXITS)

PROPOSED GRADING XXX.XX

MANHOLES

LIGHT STANDARD CATCH BASIN

FIRE HYDRANT

INDICATE NUMBER OF PARKING SPACES ACCESSIBLE PARKING SPACES

10 APR 2/24 REISSUED FOR SPA 9 SEPT. 1/22 REISSUED FOR SPA 8 MAR 22/22 4 MAY 06/20 ISSUED FOR REVIEW 3 APR. 08/20 ISSUED FOR REVIEW AUG. 08/18 ISSUED FOR REVIEW 1 AUG. 03/18 ISSUED FOR REVIEW

WANG ARCHITECTS INC. 3950 14th Ave, Unit 609 Markham, ON L3R 0A9 T: 905-604-6960 E: info@wangarchitects.ca www.wangarchitects.ca

Issued/Revision:

Project:

RIVERWOODS HOMES

RIVER ROAD WEST WASAGA BEACH, ON

Drawing Name :

SITE PLAN

Date AUGUST 2022	Project No: 18026
Scale : As indicated	
Drawn by :	Drawing No :
Checked by : HW	A1

RIVERWOODS HOMES

RIVER ROAD WEST WASAGA BEACH



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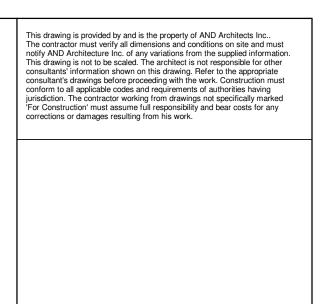
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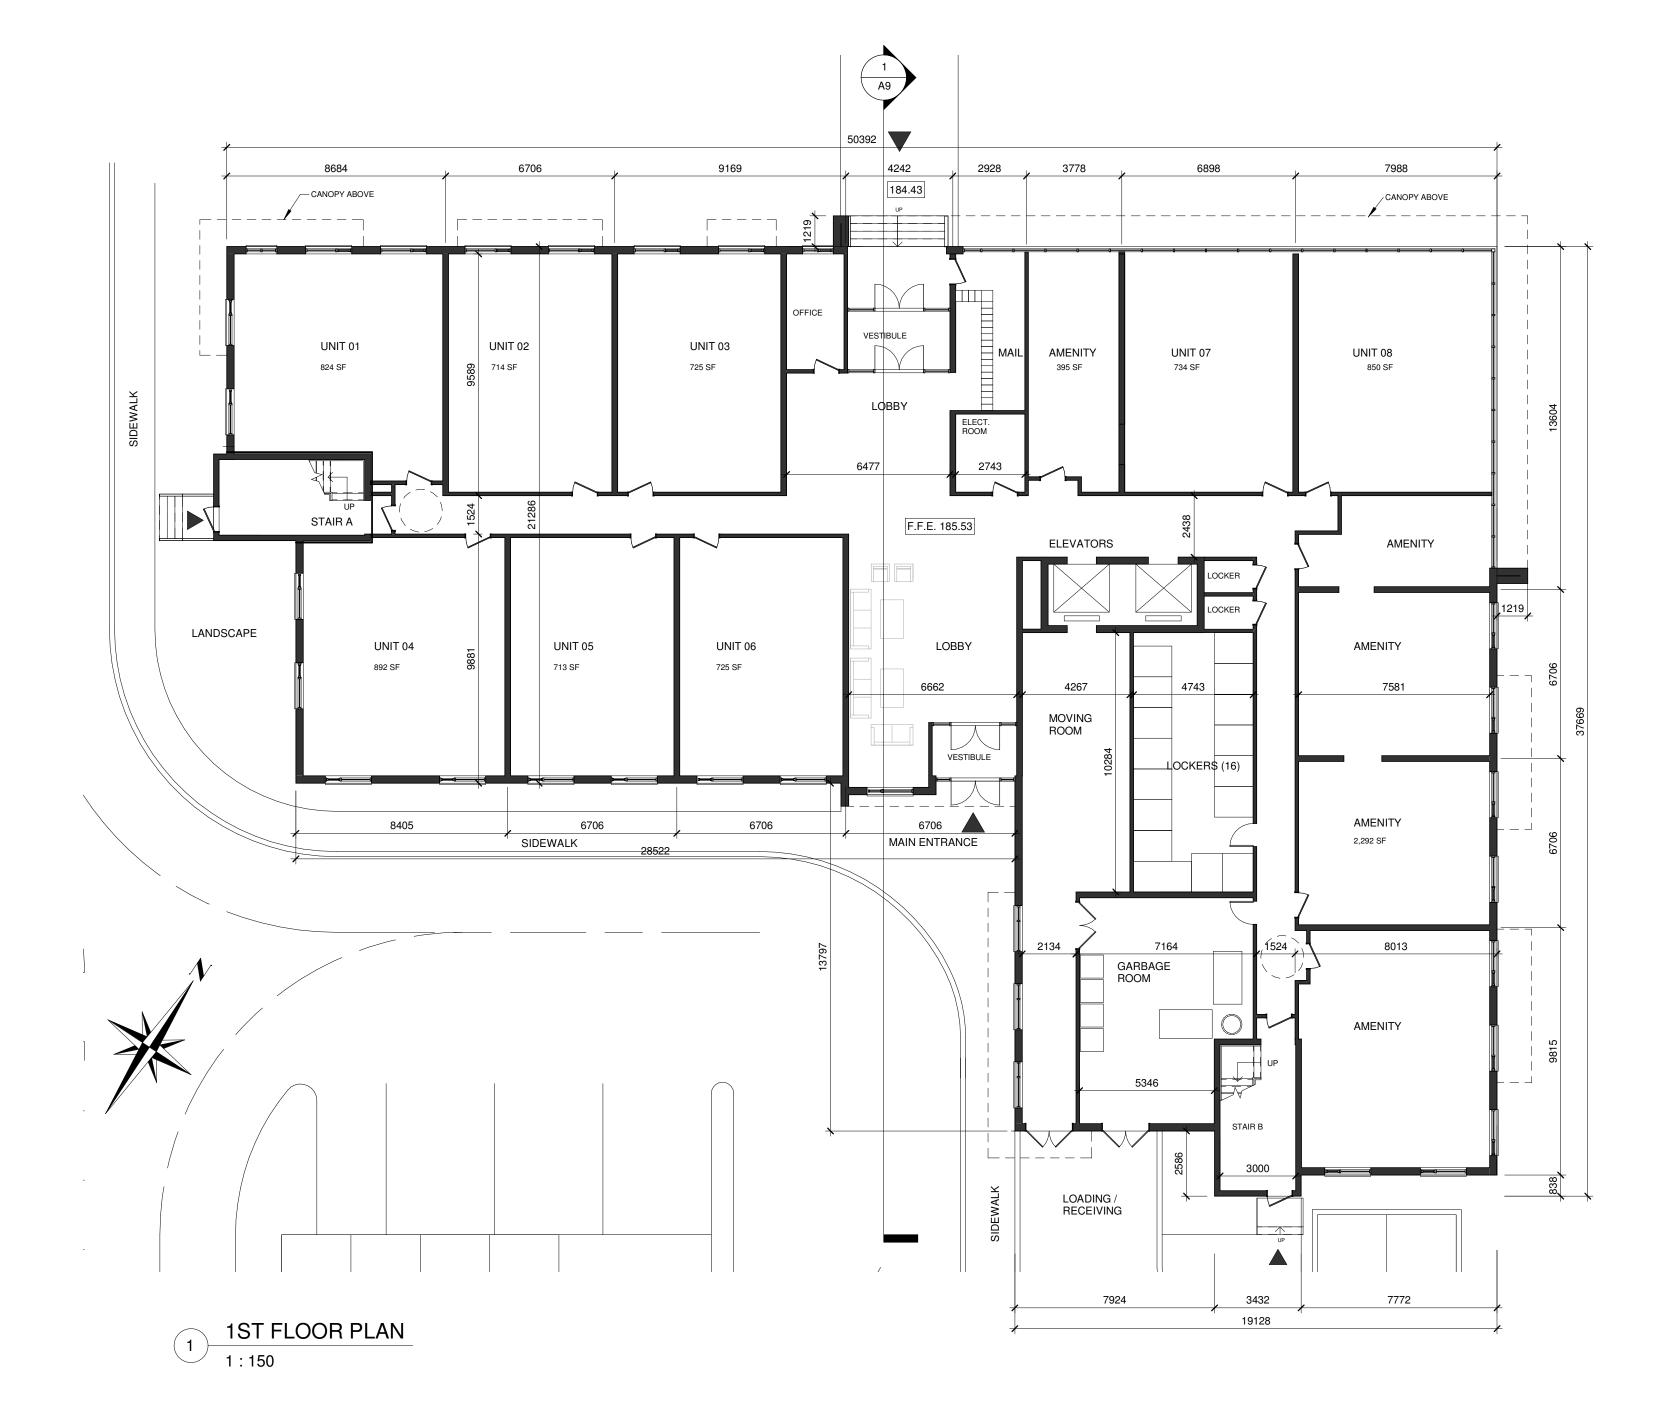
RIVER ROAD WEST WASAGA BEACH, ON

Drawing Name :

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Date JUNE 2019	Project No: 18026
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Checked by . Checker	A1
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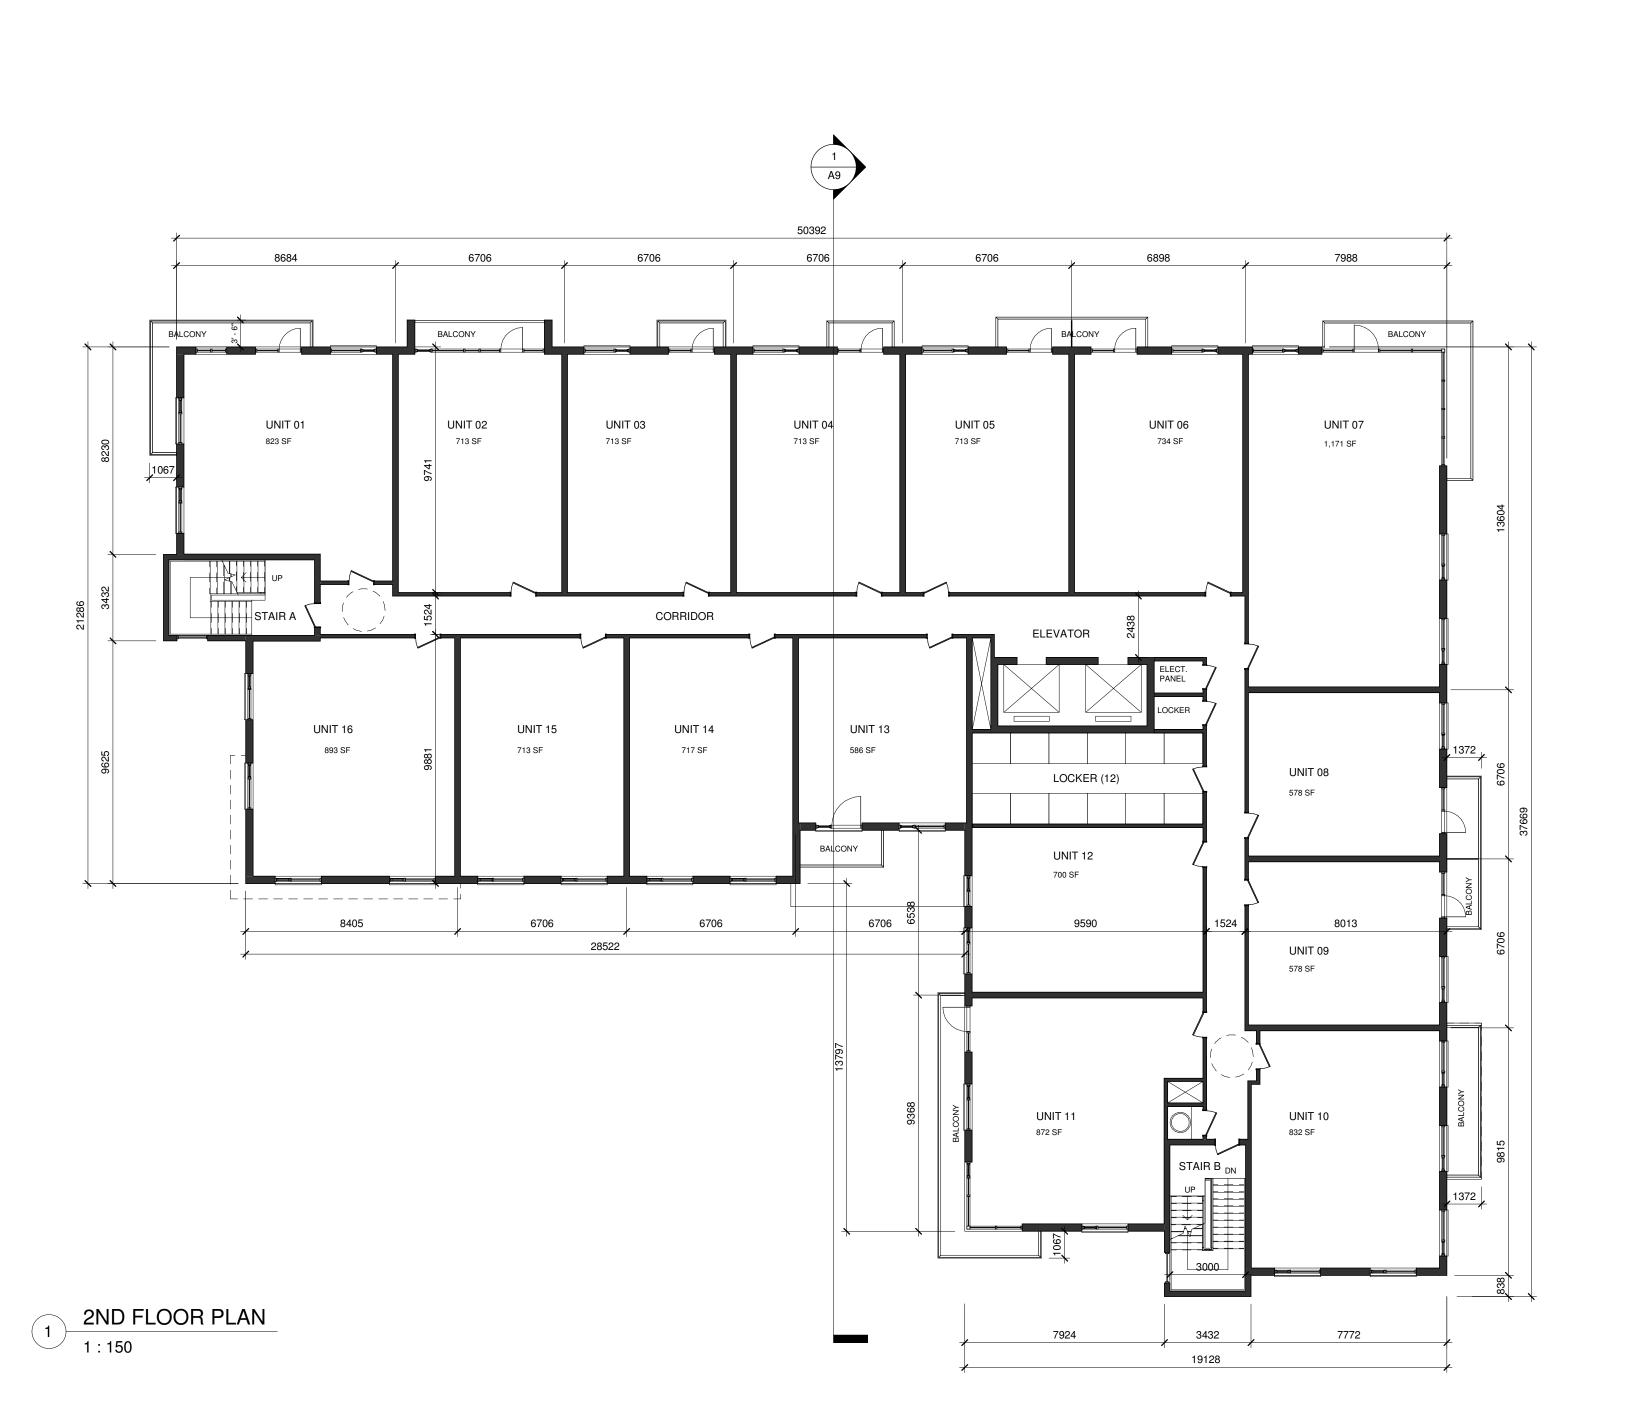
RIVERWOODS HOMES

RIVER ROAD WEST WASAGA BEACH, ON

Drawing Name :

1ST FLOOR PLAN

Date	JUNE 2019	Project No :	18026
Scale :	1:150		
Drawn by :	Author	Drawing No :	4.0
Checked by	Checker		A2



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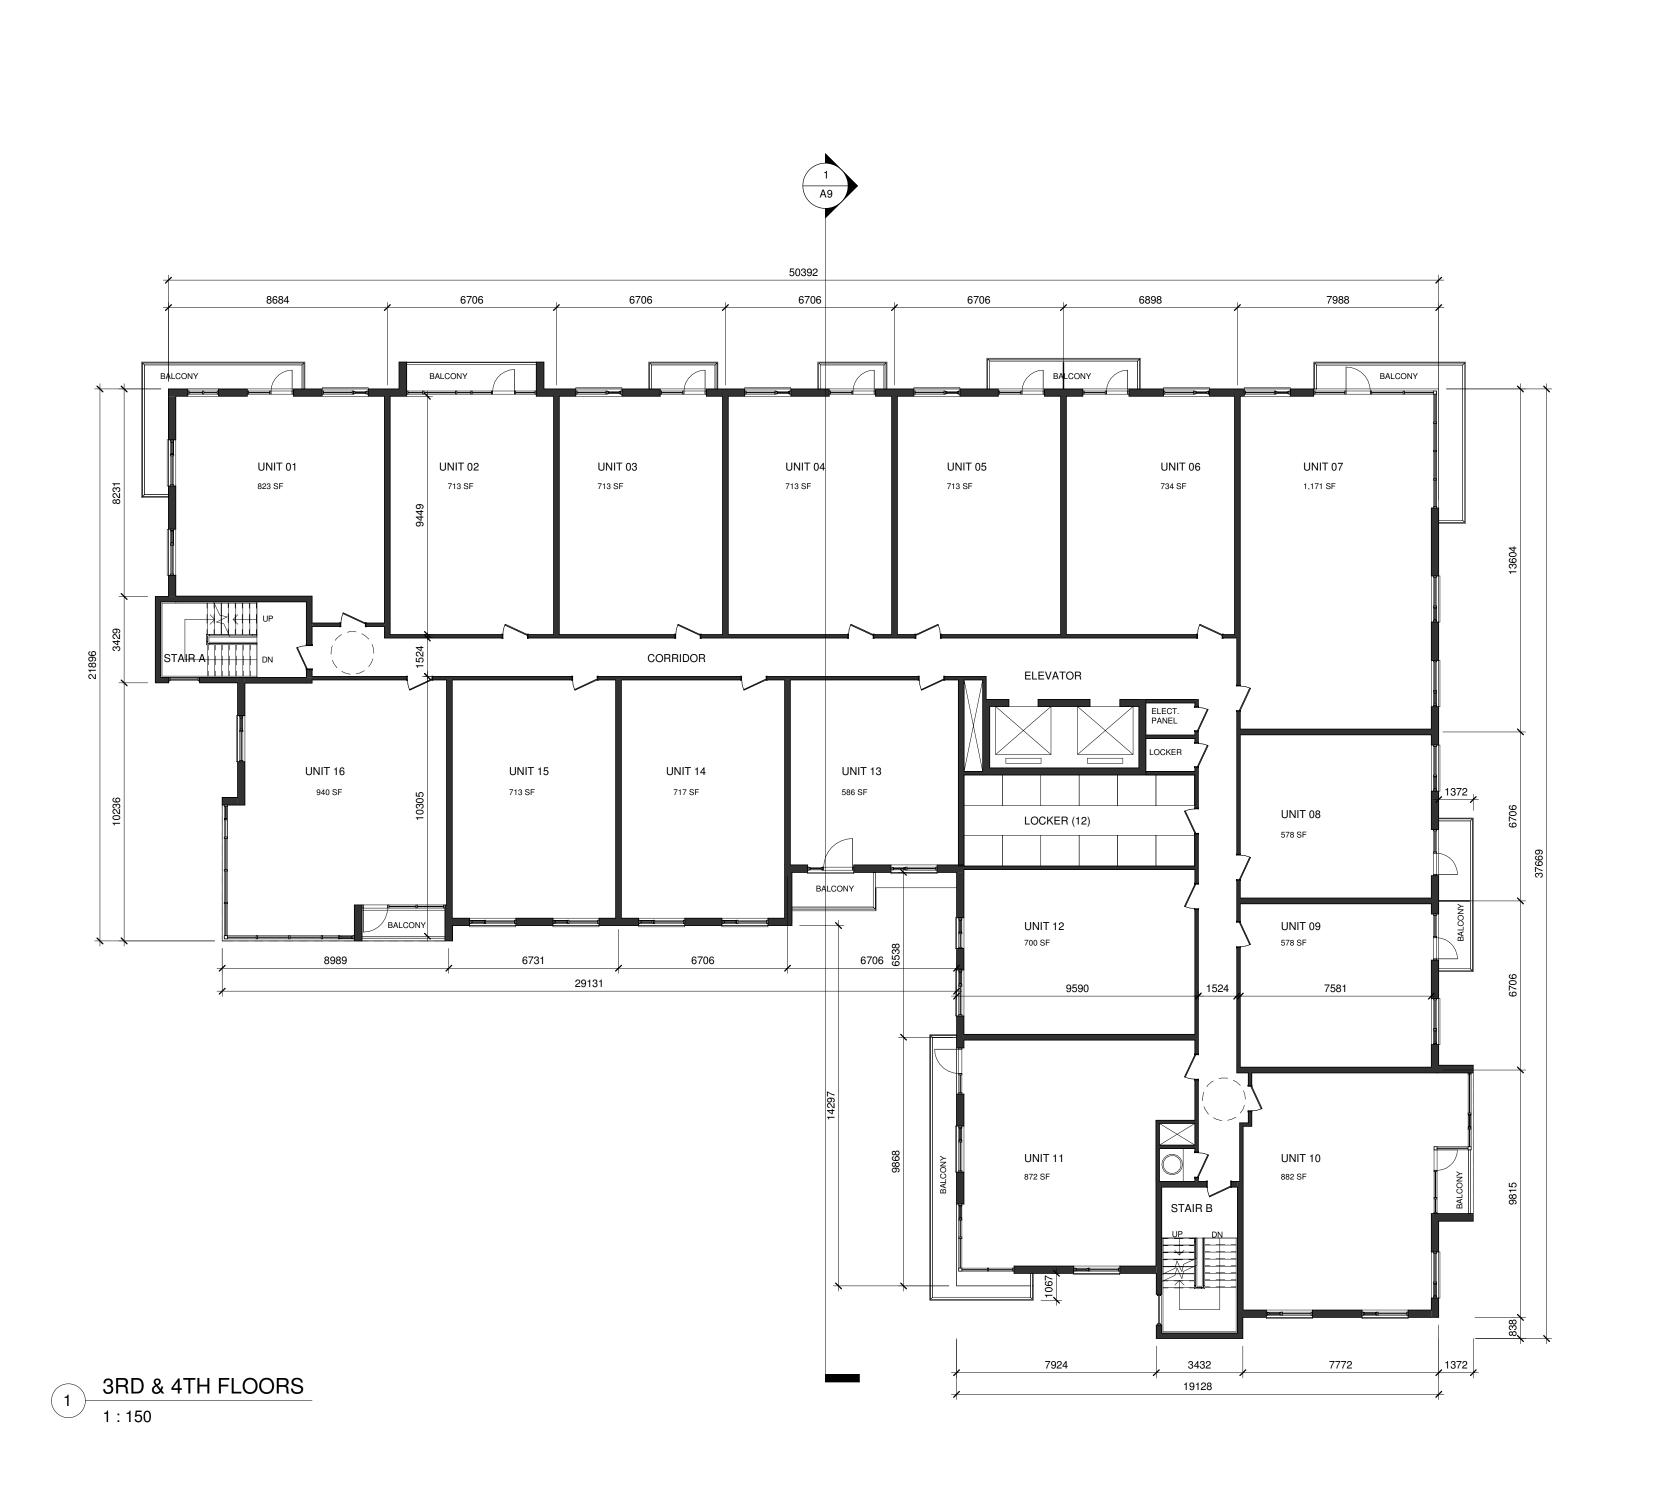
RIVERWOODS HOMES

RIVER ROAD WEST WASAGA BEACH, ON

Drawing Name :

2ND FLOOR PLAN

Date	JUNE 2019	Project No :	18026
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Drawn by :	Author	Drawing No :	4.0
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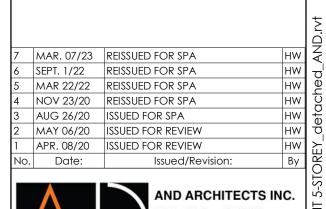
RIVERWOODS HOMES

RIVER ROAD WEST WASAGA BEACH, ON

Drawing Name :

3RD & 4TH FLOORS

Date	JUNE 2019	Project No :	18026
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Project :

RIVERWOODS HOMES


RIVER ROAD WEST WASAGA BEACH, ON

Drawing Name :

5TH FLOOR PLAN

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Project :

RIVERWOODS HOMES

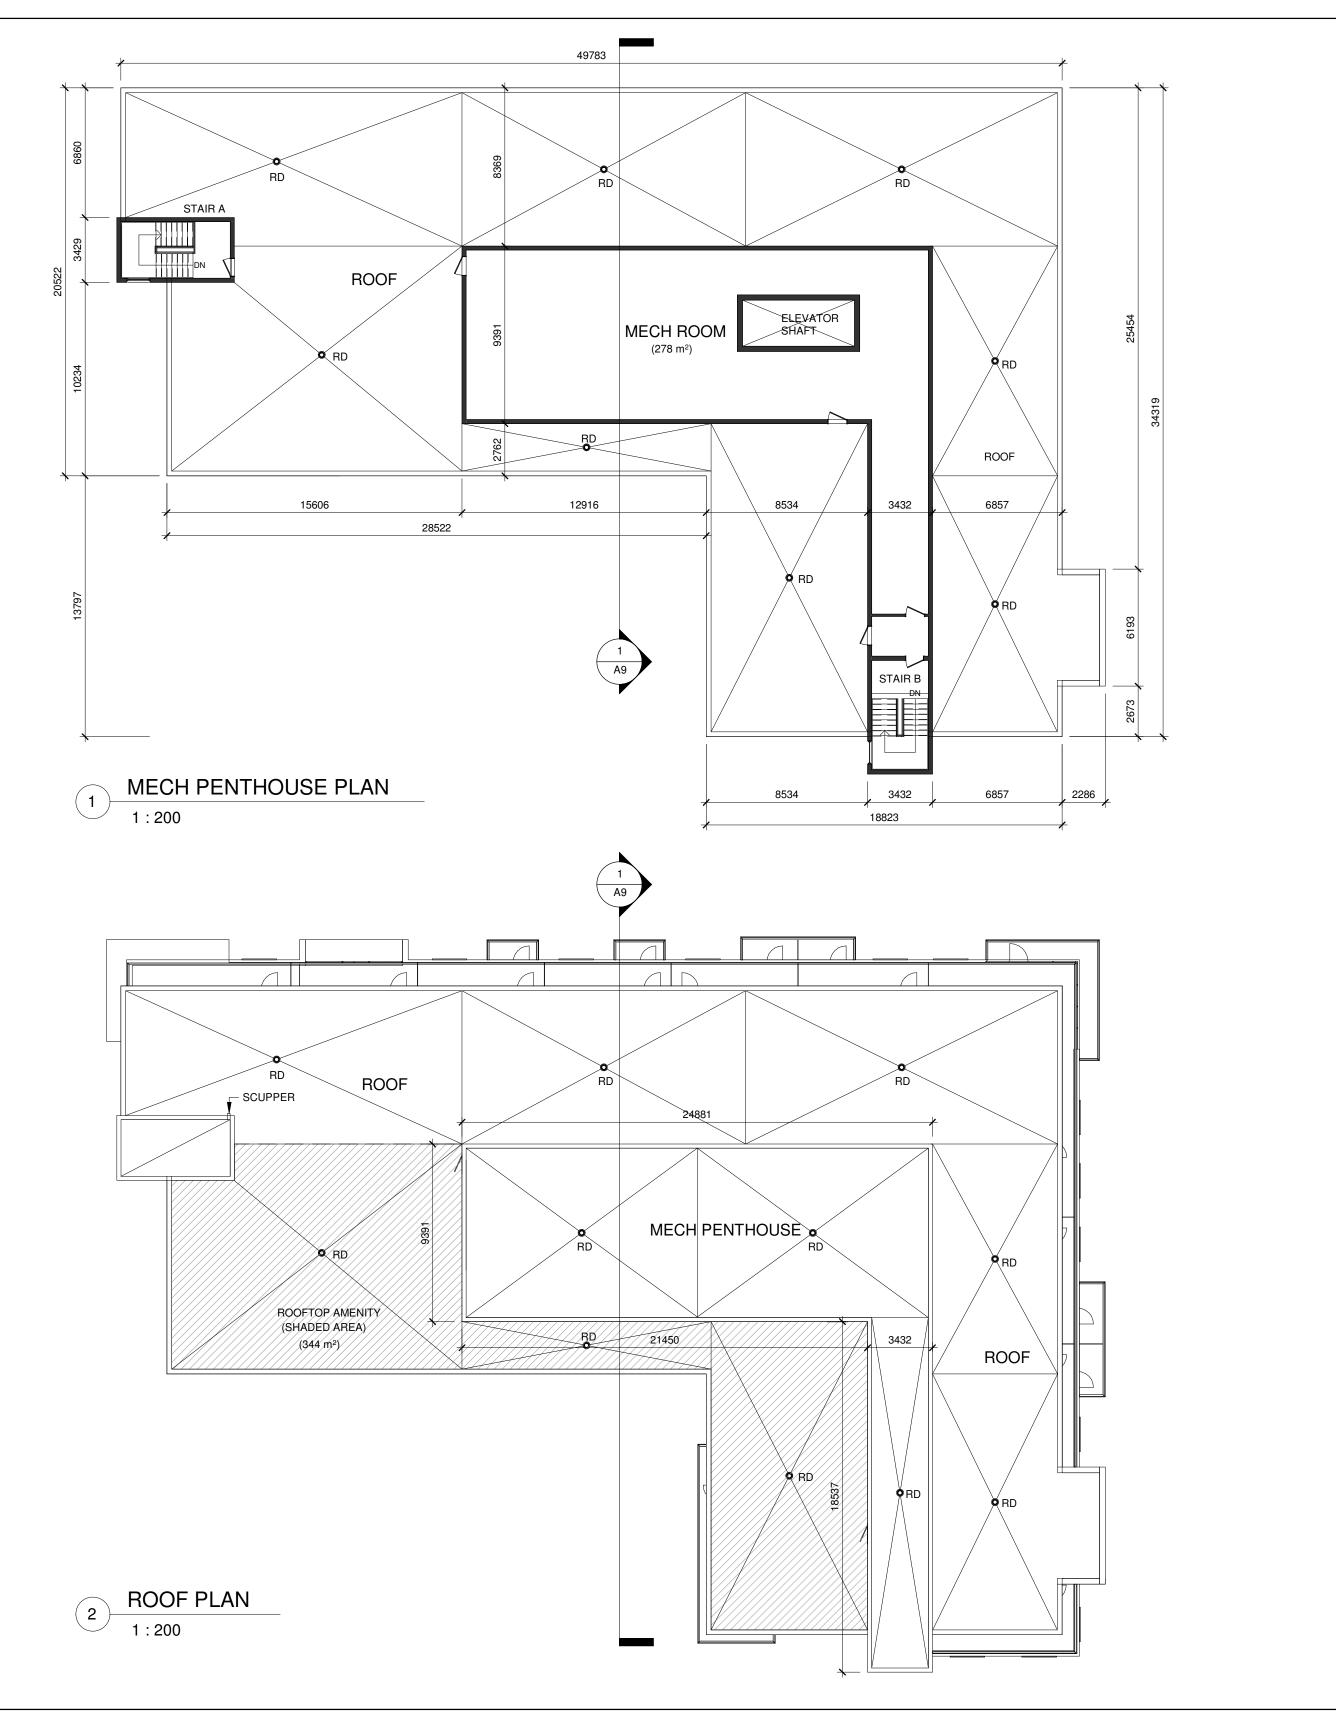RIVER ROAD WEST WASAGA BEACH, ON

Drawing Name :

MECH PENTHOUSE & ROOF PLANS

Date	JUNE 2019	Project No :	18026
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TOP OF PARAPET 206.49 - METAL SIDING - METAL SIDING MECH PENTHOUSE 202.53 - METAL PANEL Level 5 199.53 Level 4 196.53 - GLASS RAILING Level 3 193.53 - BRICK Level 2 190.53 METAL PANEL -- ARCH BLOCK PRECAST SILL Level 1 185.53 AVE. GRADE 184.97

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OF ARCHITECTS OF QING HUA (HENRY) WANG

Project :

RIVERWOODS HOMES

RIVER ROAD WEST WASAGA BEACH, ON

Drawing Name :

NORTH & SOUTH **ELEVATIONS**

JUNE 2019 Project No : 18026 1:150 Drawn by : Drawing No: Author **A**7 Checked by Checker

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PRECAST SILL	Level 1 185.53

2 SOUTH ELEVATION 1:150

NORTH ELEVATION

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1 EAST ELEVATION

TOP OF PARAPET 206.49 METAL SIDING -METAL PANEL MECH PENTHOUSE 202.53 Level 5 199.53 196.53 BRICK -GLASS RAILING -Level 3 193.53 Level 2 190.53 METAL PANEL = RIVERWOODS HOMES METAL SIDING -ARCH BLOCK Level 1 185.53 AVE. GRADE 184.97

WEST ELEVATION
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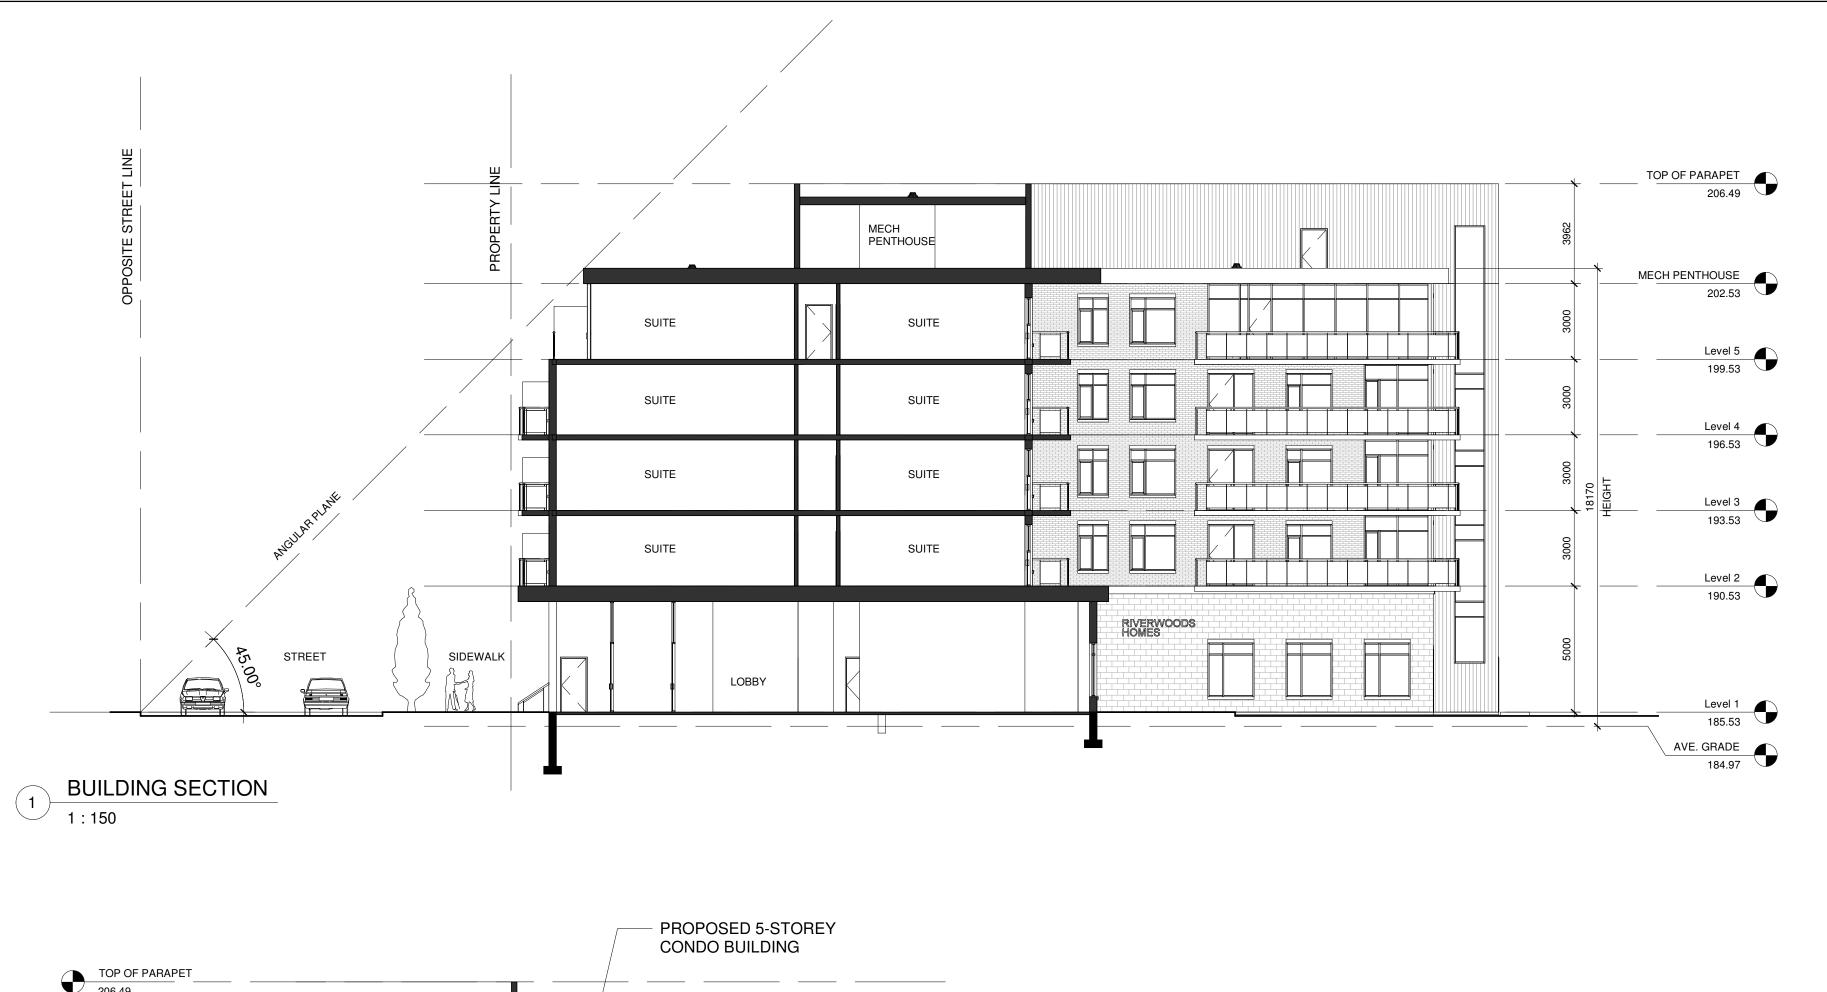
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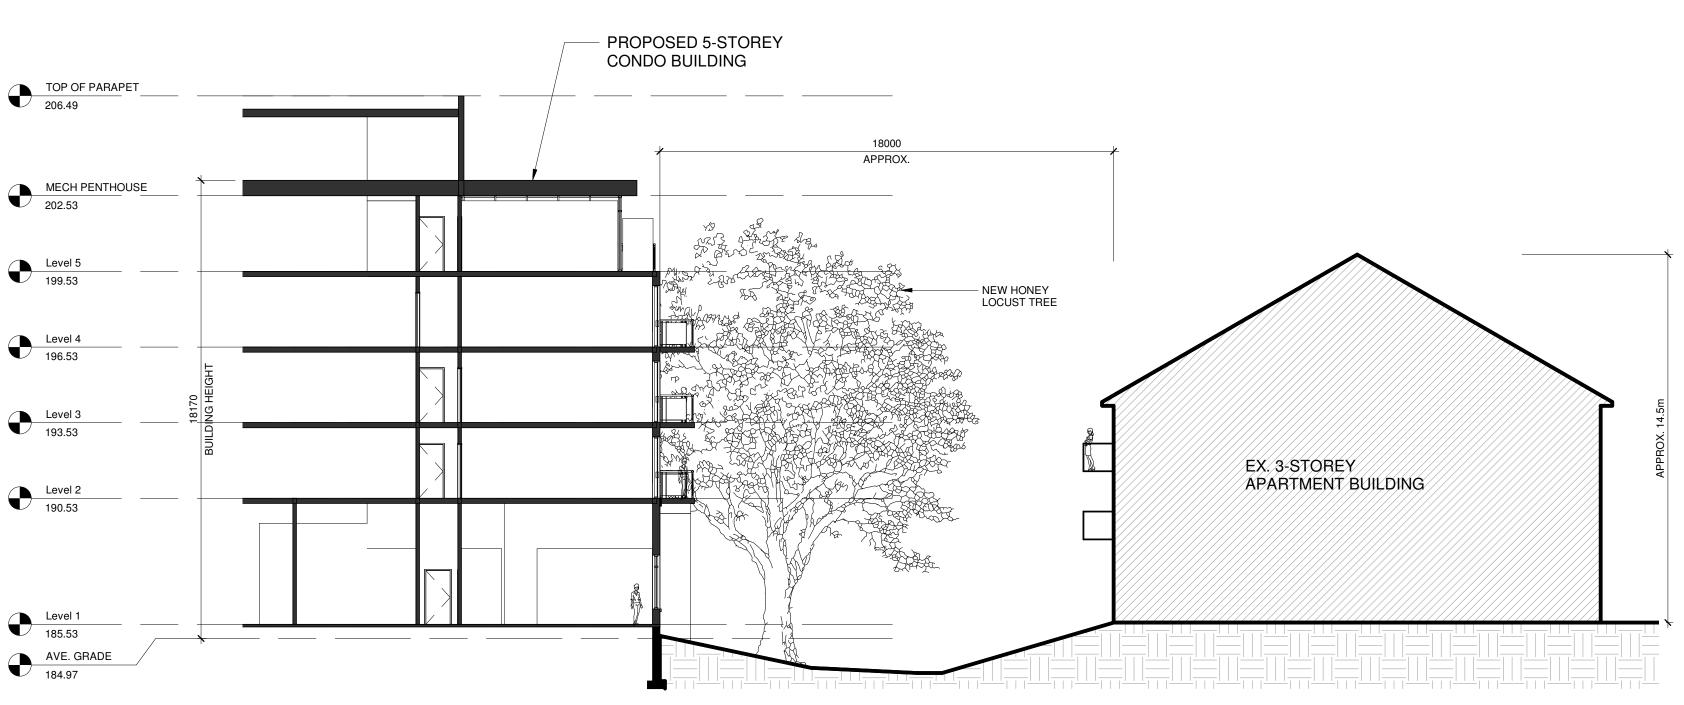
RIVER ROAD WEST WASAGA BEACH, ON

Drawing Name :

EAST & WEST ELEVATIONS

Date	JUNE 2019	Project No :	18026
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SECTION W/ EX. APARTMENT BLD TO THE EAST

1:150

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RIVERWOODS HOMES

RIVER ROAD WEST WASAGA BEACH, ON

Drawing Name :

BUILDING SECTIONS

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RIVERWOODS HOMES

RIVER ROAD WEST WASAGA BEACH, ON

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3D VIEW

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Project :

RIVERWOODS HOMES

RIVER ROAD WEST WASAGA BEACH, ON

Drawing Name :

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Project :

RIVERWOODS HOMES

RIVER ROAD WEST WASAGA BEACH, ON

Drawing Name :

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RIVERWOODS HOMES

RIVER ROAD WEST WASAGA BEACH, ON

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Project :

RIVERWOODS HOMES

RIVER ROAD WEST WASAGA BEACH, ON

Drawing Name :

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RIVERWOODS HOMES


ISSUED FOR APPROVAL MAY 8, 2024


MP COVER SHEET

L-1 LANDSCAPE PLANTING PLAN

D-1 PLANTING DETAILSD-2 LANDSCAPE DETAILSD-3 LANDSCAPE DETAILS

KEY PLAN

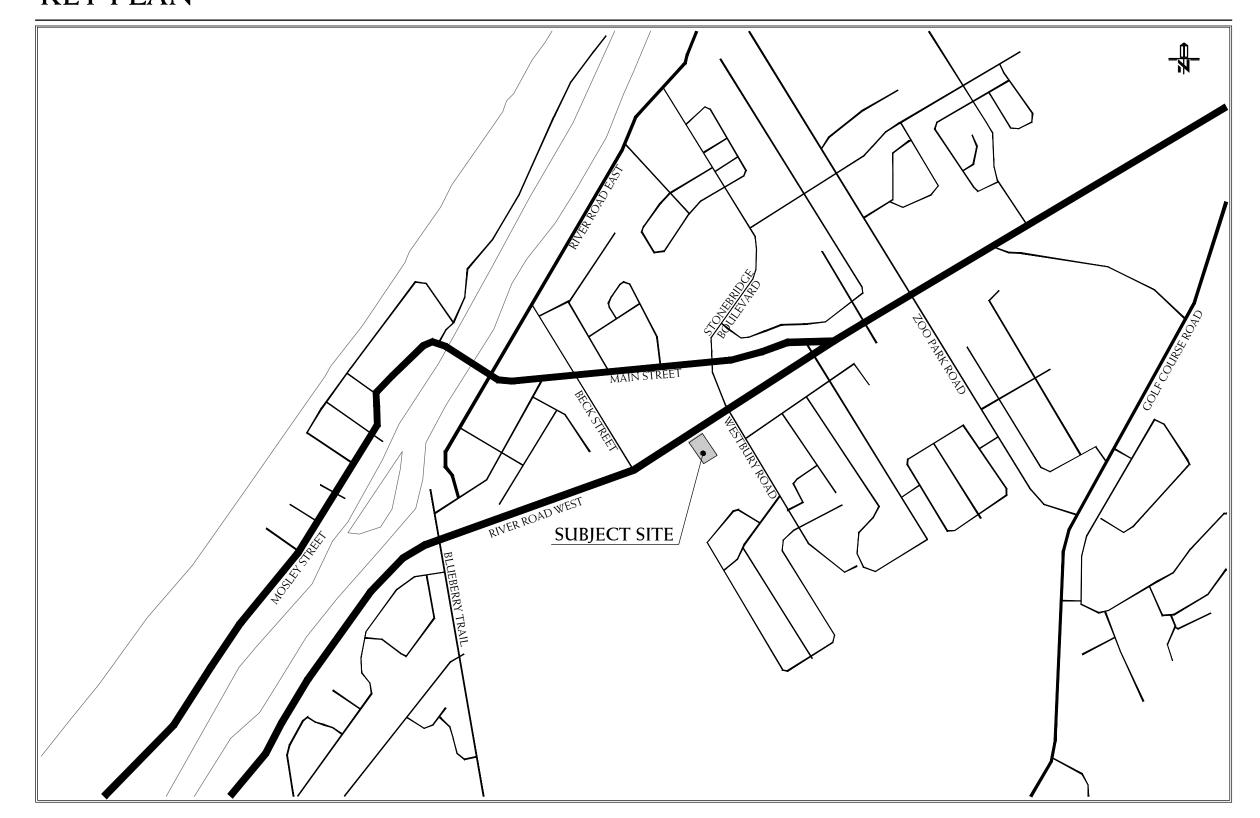

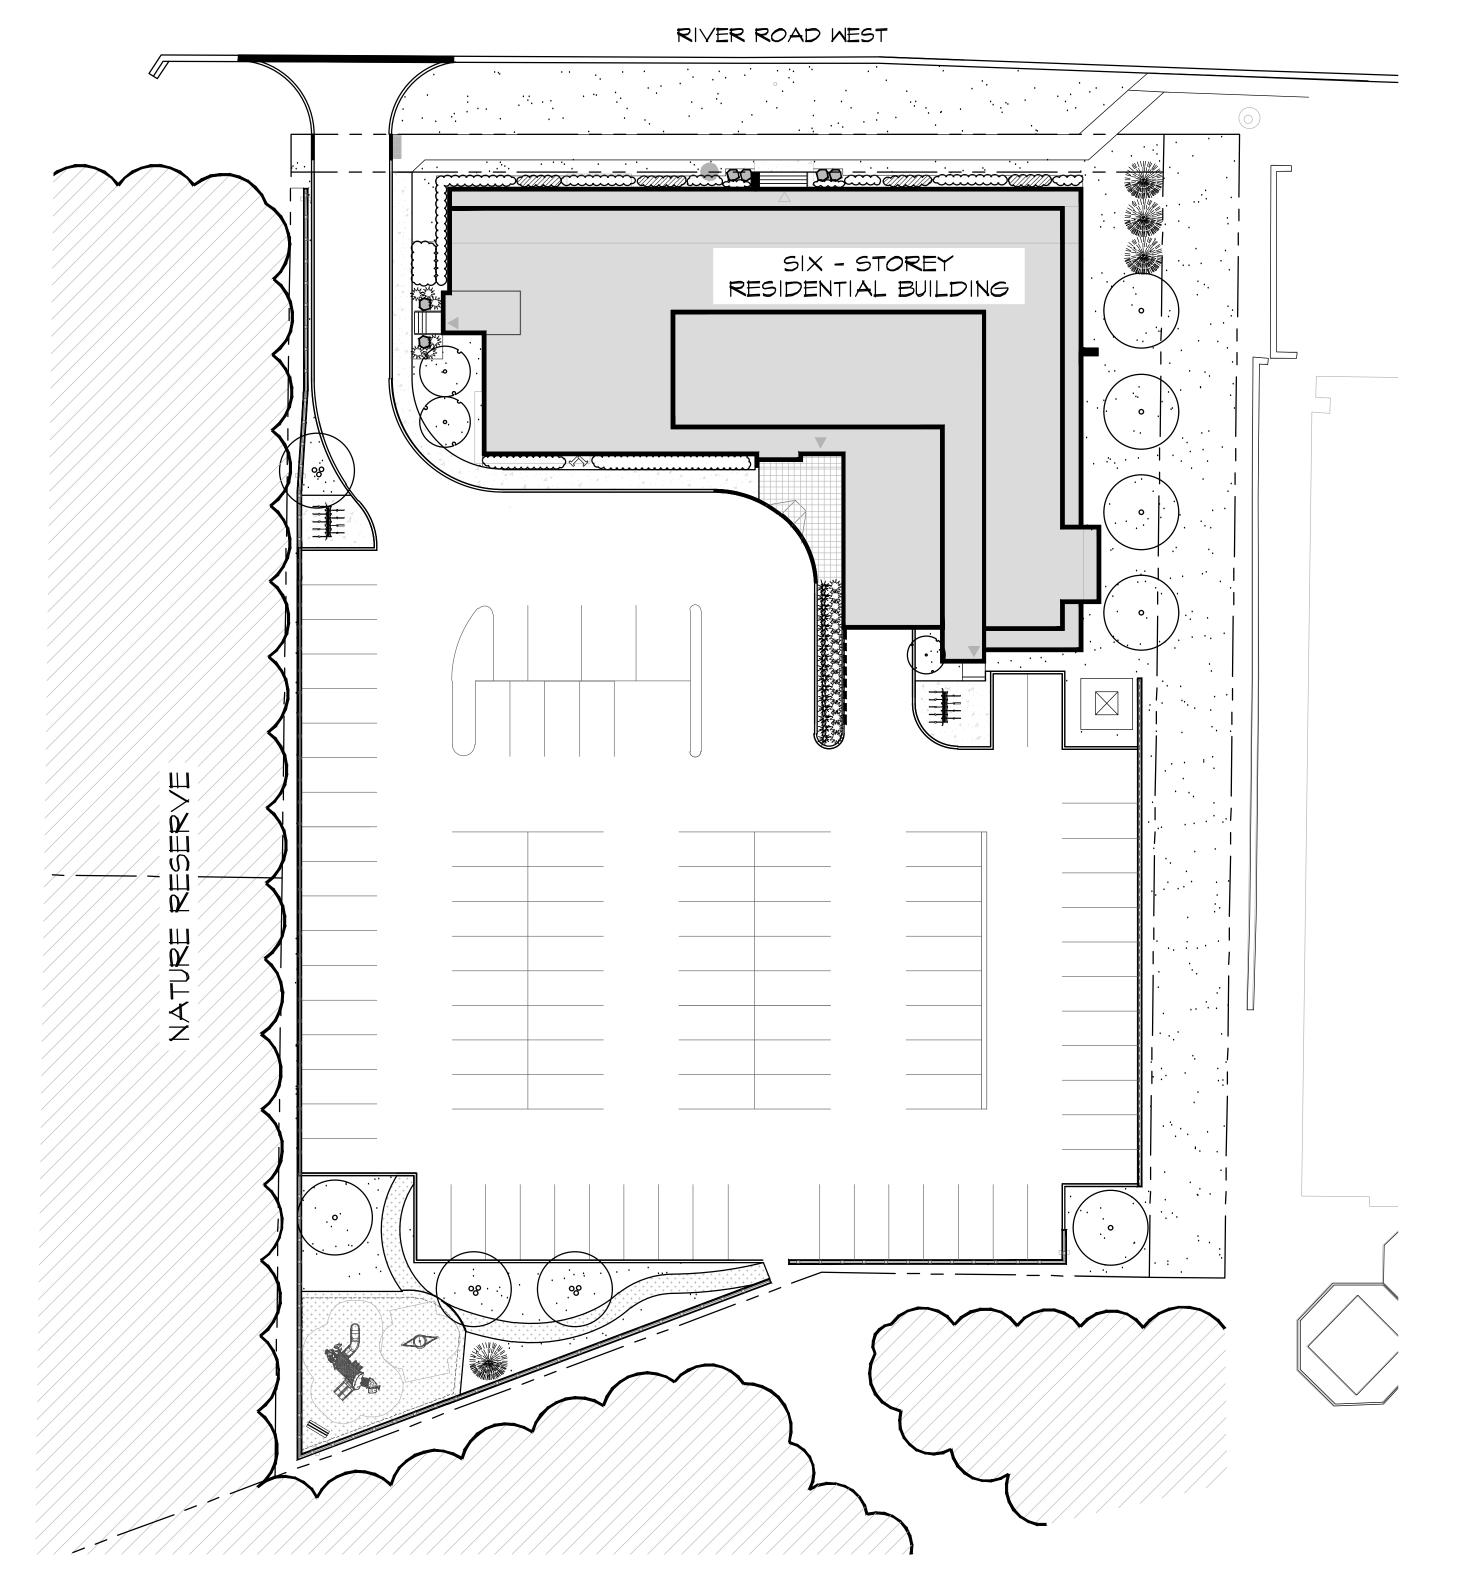

6	MAY 8 2024	ISSUED FOR APPROVAL	AV
5	JAN 18 2023	ISSUED FOR FOURTH SPA SUBMISSION	AV/ HH
4	NOV 22 2022	ISSUED FOR THIRD SPA SUBMISSION	AV/ ED
3	DEC 7 2021	ISSUED FOR SECOND SPA SUBMISSION	SO /LB
2	AUG 21 2020	ISSUED FOR ZONING & SPA SUBMISSION	RS /AV
1	JUN 31 2020	ISSUED FOR CLIENT REVIEW	LK /RS
no.	date	version	by

All information hereon to be checked and verified at the site and any discrepancies must be reported to and clarified by the landscape architect before commencing work. All drawings, specifications, details, digital information, etc., prepared by the landscape architect are instruments of service and as such are his property and must be returned at his request.





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RIVERWOODS HOMES


RIVER ROAD WEST Wasaga Beach, on

WASAGA RIVERWOODS HOMES INC.

COVER SHEET

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NOTED SCALE IS APPLICABLE ONLY WHEN PRINTED ON ARCH D (24"x36") SIZE SHEET

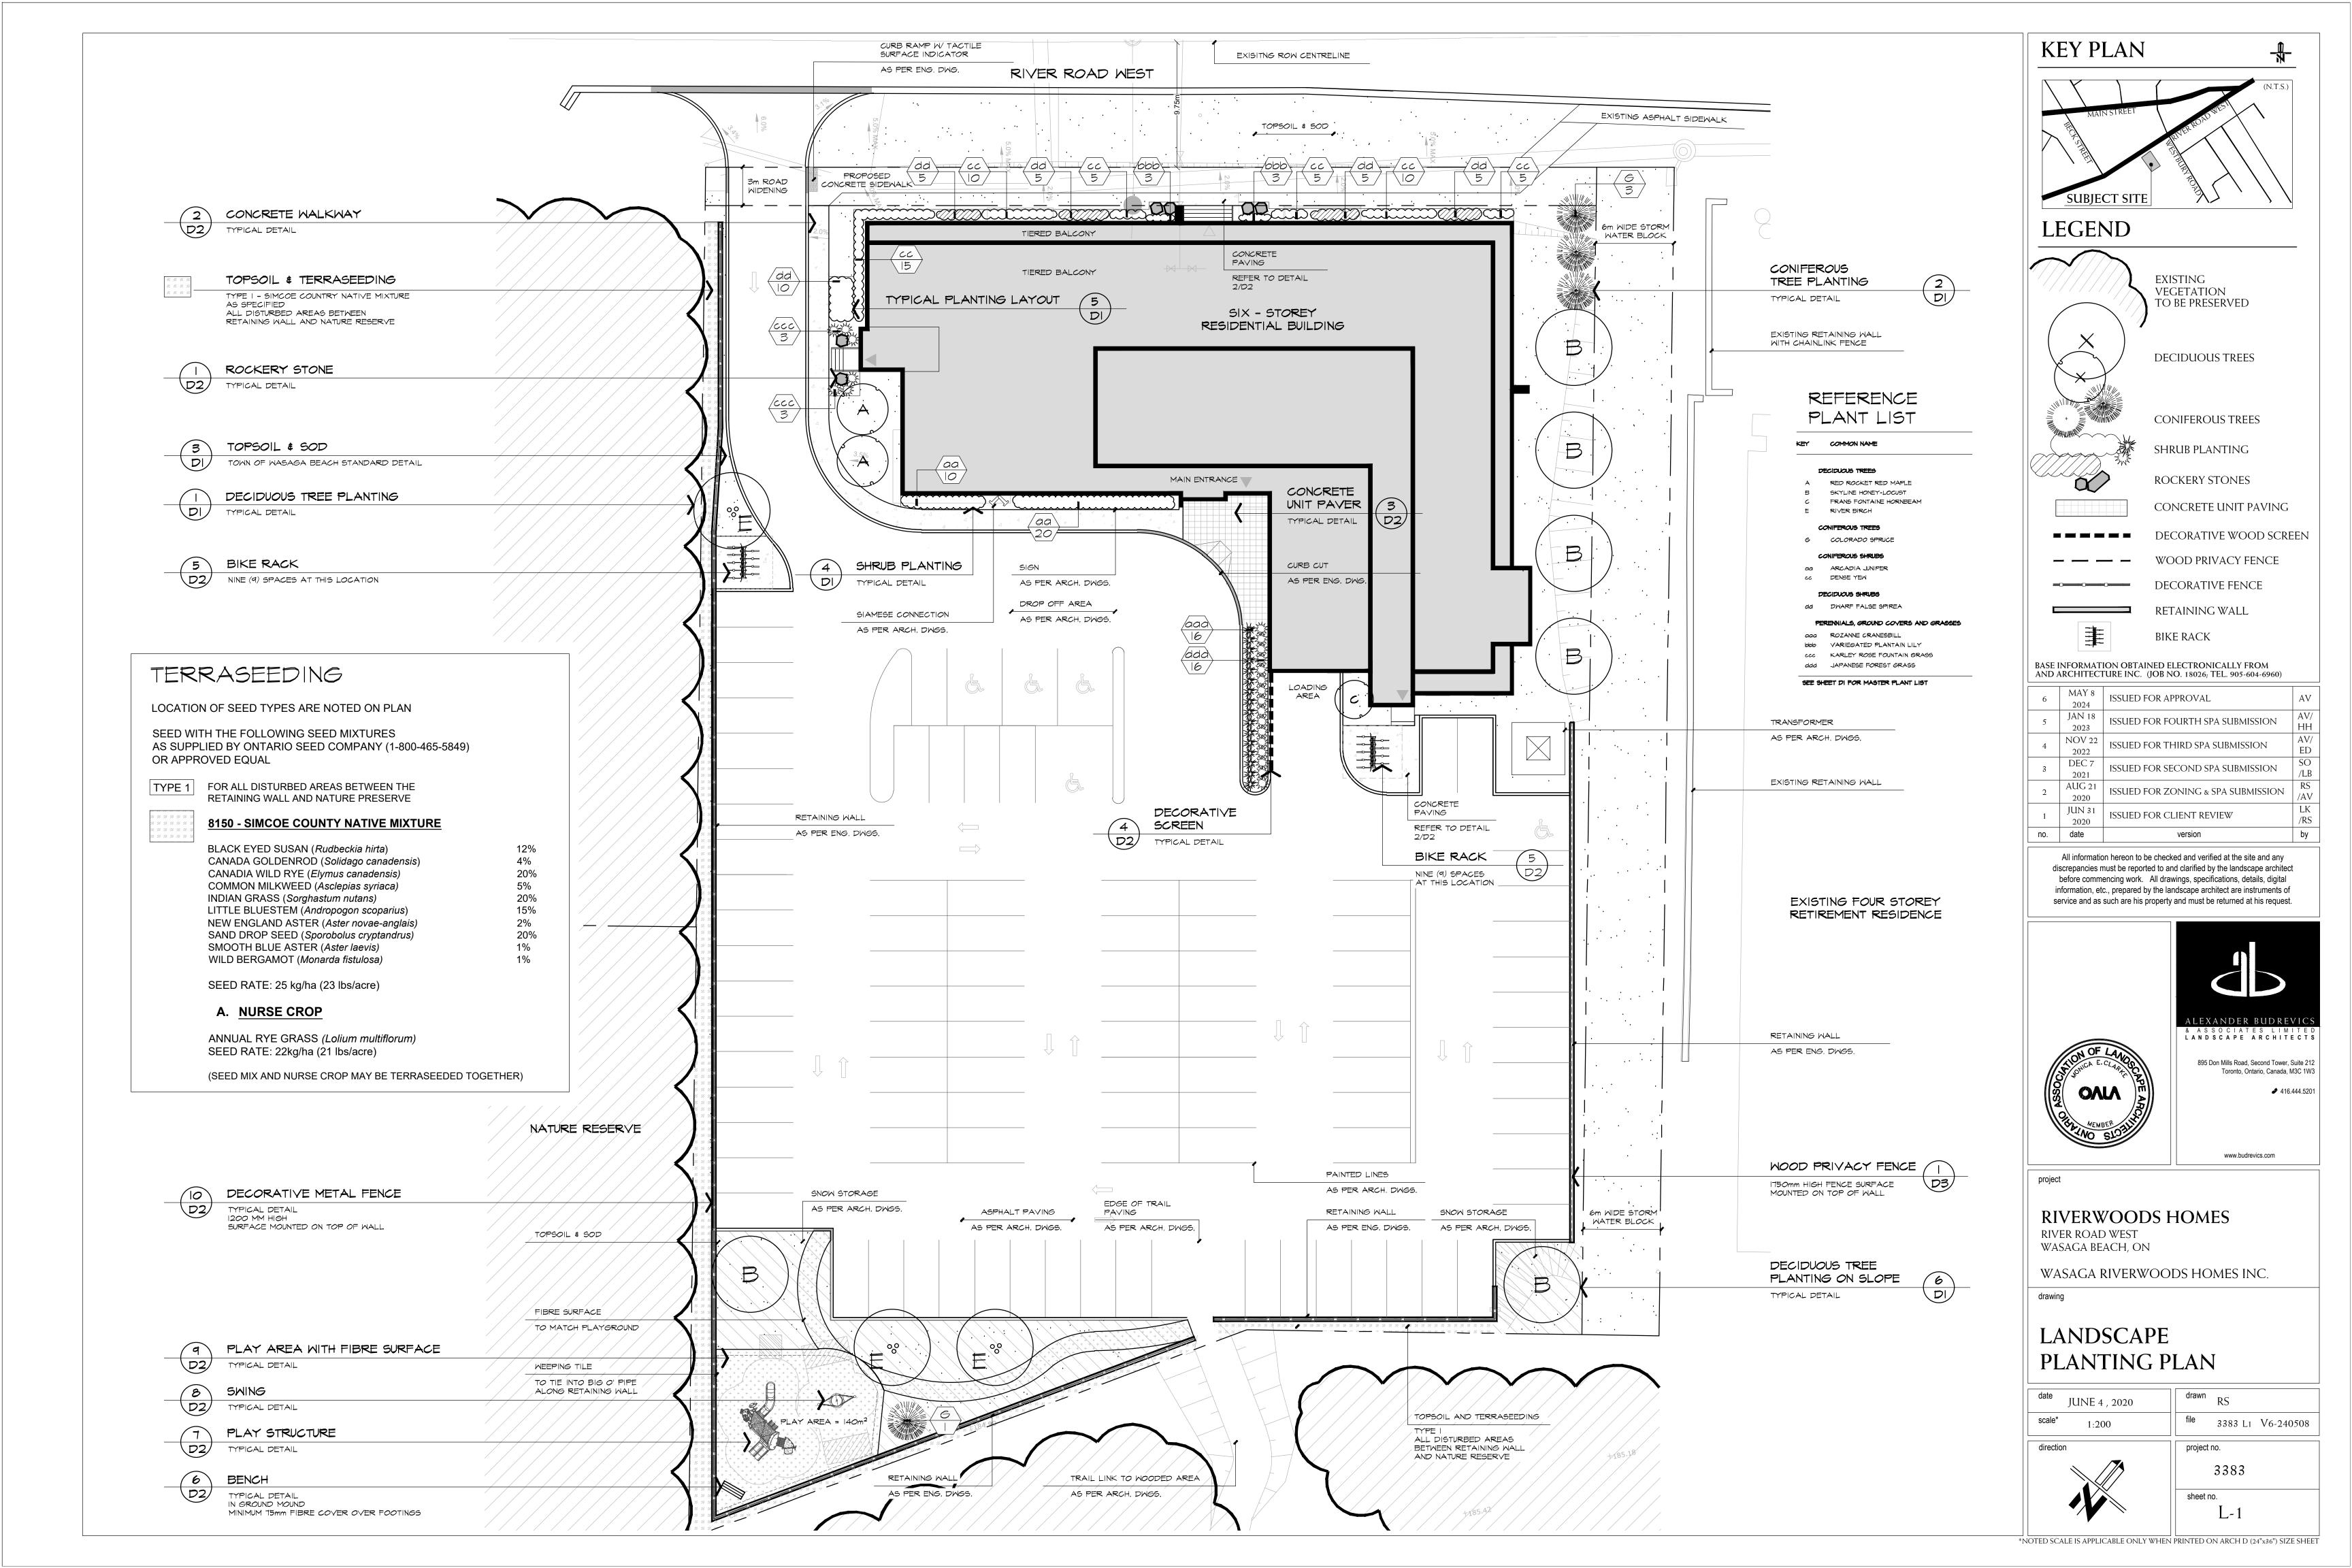

SPECIFICATIONS

THESE SPECIFICATIONS ARE TO BE READ IN CONJUNCTION WITH THE GENERAL CONDITIONS OF THE CONTRACT AS PREPARED BY AND AVAILABLE AT THE OFFICE OF ALEXANDER BUDREVICS &

PRIOR TO COMMENCING WORK, THE CONTRACTOR SHALL: FAMILIARIZE HIMSELF WITH THE PLANS, DETAILS, AND SPECIFICATIONS OF THIS VISIT THE SITE TO ASCERTAIN AND TAKE ACCOUNT OF EXISTING CONDITIONS AND ANY DEVIATIONS FROM THE PLANS IN WORK BY OTHERS, AND FINALIZE ALL DESIGN ALTERNATIVES IN CONSULTATION WITH THE LANDSCAPE

PRIOR TO EXCAVATING, THE CONTRACTOR SHALL VERIFY THE LOCATION OF ALL UNDERGROUND UTILITIES. IN THE EVENT OF A CONFLICT BETWEEN A PROPOSED TREE LOCATION AND AN UNDERGROUND SERVICE, THE EXACT LOCATION OF THE TREE SHALL BE DETERMINED ON SITE BY

THE CONTRACTOR SHALL, AT HIS OWN EXPENSE, REPAIR ANY DAMAGE TO EXISTING UTILITIES, STRUCTURES, FACILITIES, ETC. DONE IN THE PERFORMANCE OF HIS WORK.

ALL SITE WORK SHALL CONFORM TO THE <u>CANADIAN NATIONAL MASTER CONSTRUCTION</u>
<u>SPECIFICATIONS</u>, A COPY OF WHICH CAN BE OBTAINED FROM CONSTRUCTION SPECIFICATIONS

Tel. (416) 777-2198, Fax. (416) 777-219, Email. info@csc-dcc.ca.
IT IS THE RESPONSIBILITY OF THE CONTRACTOR TO BE THOROUGHLY FAMILIAR WITH THESE SPECIFICATIONS AND THEIR IMPLICATIONS FOR THIS PROJECT.

SOFT LANDSCAPING

PLANT MATERIALS ALL PLANTS SHALL BE INSTALLED TRUE TO SPECIFIED NAMES, SIZES, GRADES, ETC. AND SHALL CONFORM TO THE STANDARDS OF THE CANADIAN NURSERY TRADES ASSOCIATION. ALL PLANTS SHALL BE NURSERY GROWN

IN THE EVENT OF A DISCREPANCY IN PLANT QUANTITY BETWEEN THE PLANTING PLAN AND THE

THE CONTRACTOR SHALL MAKE PLANTS AVAILABLE FOR INSPECTION BY THE LANDSCAPE ARCHITECT PRIOR TO INSTALLATION. MATERIAL NOT CONFORMING TO THE SPECIFICATIONS SHALL BE REPLACED AT THE EXPENSE OF THE CONTRACTOR.

PLANT SUBSTITUTIONS MUST BE APPROVED IN WRITING BY THE OWNER OR THE LANDSCAPE ARCHITECT PRIOR TO DELIVERY OF THE MATERIAL ON SITE.

THE LANDSCAPE ARCHITECT MAY, UPON COMPLETION OF THE WORK AND NOTWITHSTANDING PRIOR APPROVAL AT SOURCE, REJECT PLANT MATERIAL NOT CONFORMING TO THE

THE CONTRACTOR SHALL USE STANDARD INDUSTRY METHODS FOR PLANTING TREES. TREES SHALL BE TURNED TO GIVE THE BEST APPEARANCE: THEY SHALL ALSO BE GUYED AND STAKED IMMEDIATELY AFTER PLANTING AND AS DETAILED ON THE DRAWINGS.

BED PREPARATION THE CONTRACTOR SHALL BACKFILL TREE PITS AND PLANTING BEDS TO SPECIFIED DEPTHS WITH EITHER PRE-MIXED TOPSOIL (VIZ., "TRIPLE-MIX") OR A MIXTURE COMPRISED OF:

6 PARTS SANDY LOAM 1 PART FINELY PULVERIZED CANADIAN PEAT MOSS 1 PART WELL-ROTTED FARM MANURE. WITH "AGRIFORM" 20-10-5

MANUFACTURER'S SPECIFICATIONS. THE CONTRACTOR SHALL CONSTRUCT TREE PITS AND SHRUB BEDS WITH SOIL SAUCERS, MULCH, AND SUBSURFACE DRAINAGE AS DETAILED.

THE CONTRACTOR SHALL CONSTRUCT SHRUB BEDS IN CONTINUOUS FORMS. THE SHAPE OF WHICH SHALL BE APPROVED BY THE LANDSCAPE ARCHITECT AND/OR OWNER. ON SLOPES, SHRUB BEDS SHALL BE FASHIONED TO ALLOW FOR PROPER DRAINAGE.

TOPSOIL & FINE GRADING THE CONTRACTOR SHALL PLACE 150mm OF RICH TOPSOIL ON APPROVED SUBGRADES. TOPSOIL SHALL BE IMPORTED WHERE REQUIRED. 10-6-4 FERTILIZER SHALL BE APPLIED ACCORDING TO THE

MANUFACTURER'S INSTRUCTIONS AT A RATE OF 7.32 kg/100m² FOR SODDED AREAS; THE MIXTURE AND RATE OF APPLICATION SHALL BE ADJUSTED FOR SEEDED AREAS. MINOR GRADE DEFICIENCIES AND IRREGULARITIES SHALL BE ELIMINATED PRIOR TO SODDING.

SODDING THE CONTRACTOR SHALL SOD ALL AREAS SO INDICATED ON THE DRAWINGS. SOD SHALL BE FRESHLY CUT NO.1 GRADE NURSERY-GROWN TURF 50-75mm THICK.

SOD FOR SUNNY, EXPOSED AREAS SHALL BE 50% KENTUCKY BLUEGRASS AND 50% MERION BLUEGRASS. SOD FOR SHADED AREAS SHALL BE 50% NUGGET KENTUCKY BLUEGRASS AND 50% CREEPING RED FESCUE.

SOD SHALL BE PLACED ON PREPARED TOPSOIL, WITH JOINTS STAGGERED AND SECTIONS ABUTTED TIGHTLY. IMMEDIATELY AFTER LAYING, IRRIGATION SUFFICIENT TO ENSURE MOISTURE PENETRATION TO A DEPTH OF 100mm SHALL BE APPLIED.

SOD SHALL BE MACHINE ROLLED TO ENSURE UNIFORM CONTACT WITH TOPSOIL. SOD ON ALL SLOPES SHALL BE PEGGED WHERE REQUIRED.

TERRASEEDING

THE CONTRACTOR SHALL FINE GRADE AND FERTILIZE AS RECOMMENDED BY SOIL TEST ANALYSIS REPORT. MINOR GRADE DEFICIENCIES AND IRREGULARITIES SHALL BE ELIMINATED PRIOR TO

THE CONTRACTOR SHALL TERRASEED ALL AREAS WITH SPECIFIED SEED MIXTURES AS NOTED ON

DEPENDING ON SLOPE GRADATION, DEPTH OF COMPOSTED SOIL, SEED SHALL BE AS FOLLOWS: 0-5% SLOPE: 10-15 mm. DEPTH

5-10% SLOPE: 15-20 mm. DEPTH 10-25% SLOPE: (4:1) 20-25 mm. DEPTH 25-35% SLOPE: (3:1) 25-40 mm. DEPTH

MASTER PLANT LIST

ACER RUBRUM 'RED ROCKET'

JUNIPERUS SABINA 'ARCADIA'

TAXUS MEDIA 'DENSIFORMIS'

SORBARIA SORBIFOLIA 'SEM'

HOSTA FORTUNEI 'ALBOMARGINATA'

PENNISETUM ORIENTALE KARLEY ROSE'

GERANIUM x ROZANNE

HAKONECHLOA MACRA

GLEDITSIA TRIACANTHOS 'SKYLINE'

CARPINUS BETULUS 'FRANS FONTAINE'

KEY QUANTITY BOTANICAL NAME

DECIDUOUS TREES

E 3 BETULA NIGRA

6 4 PICEA PUNGENS

CONFEROUS SHRUBS

DECIDUOUS SHRUBS

35-45% SLOPE: 40-50 mm, DEPTH THE CONTRACTOR SHALL FERTILIZE AS RECOMMENDED BY SEED SUPPLIER.

WATER AS REQUIRED TO OBTAIN THICK GROWTH. FOLLOW UP OVERSEEDING IS PART OF THIS

STONEWORK OR PAVING WORK.

POURED-IN-PLACE CONCRETE WORK THE CONTRACTOR SHALL OBTAIN WRITTEN APPROVAL OF FORMWORK PRIOR TO POURING CONCRETE. ALL CONCRETE, STEEL REINFORCING, AND FORMWORK SHALL BE AS DETAILED AND SPECIFIED ON THE DRAWINGS.

THE STYLE, COLOUR, AND FINISH OF CONCRETE ELEMENTS SHALL BE APPROVED BY THE OWNER AND/OR LANDSCAPE ARCHITECT PRIOR TO THE COMMENCEMENT OF CONCRETE WORK. ALL STRUCTURAL CONCRETE WORK SHALL CONFORM TO LOCAL BUILDING CODES AND

BRICKWORK, STONEWORK & CONCRETE UNIT PAVING WHERE APPLICABLE. THE CONTRACTOR SHALL OBTAIN WRITTEN APPROVAL FROM THE LANDSCAPE ARCHITECT OF ALL STRUCTURAL CONCRETE WORK BEFORE COMMENCING BRICKWORK,

ALL BRICKWORK, STONEWORK, AND CONCRETE UNIT PAVING SHALL BE AS DETAILED AND SPECIFIED ON THE DRAWINGS, UNLESS THE LANDSCAPE ARCHITECT AND/OR THE OWNER

PRIOR TO STARTING THIS PORTION OF WORK, THE CONTRACTOR SHALL SUBMIT SAMPLES OF ALL PROPOSED BRICKWORK, STONEWORK, AND CONCRETE UNIT PAVERS FOR APPROVAL BY THE LANDSCAPE ARCHITECT AND/OR THE OWNER WITH RESPECT TO STYLE, COLOUR, AND FINISH, THE CONTRACTOR MAY ALSO BE ASKED TO SUBMIT SAMPLES OF ALTERNATIVES TO THE MATERIALS SPECIFIED ON THE DRAWINGS.

ALL BRICKWORK, STONEWORK, AND CONCRETE UNIT PAVING SHALL CONFORM TO LOCAL BUILDING CODES AND OTHER MUNICIPAL REQUIREMENTS.

WOODWORK ALL WOOD SHALL BE NO. 1 GRADE DRESSED CLEAR CEDAR, PRESSURE-TREATED RED PINE, OR PRESSURE-TREATED JACK PINE, AS SPECIFIED ON THE DRAWINGS.

PRESSURE TREATMENT SHALL BE FACTORY-APPLIED COPPER CHROME ARSENATE OR EQUAL, AS PER CSA-080 SPECIFICATIONS CLEAR CEDAR OR SPECIALTY WOODS SHALL BE STAINED WITH TWO (2) COATS OF STAIN, PAINT OR

THE CONTRACTOR SHALL SUBMIT SAMPLES OF ALL PROPOSED FINISHES FOR APPROVAL BY THE LANDSCAPE ARCHITECT AND/OR THE OWNER PRIOR TO ITS APPLICATION. THE CONTRACTOR MAY ALSO BE ASKED TO SUBMIT SAMPLES OF ALTERNATIVES TO THE MATERIALS OR FINISHES SPECIFIED ON THE DRAWINGS.

PRIOR TO ORDERING MATERIAL FOR THIS PORTION OF WORK, THE CONTRACTOR SHALL SUBMIT SAMPLES OF ALL PROPOSED METALWORK FOR THE APPROVAL OF THE LANDSCAPE ARCHITECT AND/OR THE OWNER WITH RESPECT TO STYLE, COLOUR, AND FINISH. THE CONTRACTOR MAY ALSO

NUMBER OF SECTIONS OF FENCE OR THE SIZE OF GATES THAT WILL BE NEEDED.

BE ASKED TO SUBMIT SAMPLES OF ALTERNATIVES TO THE MATERIALS SPECIFIED ON THE LENGTHS FOR FENCING SHALL BE MEASURED IN THE FIELD BY THE CONTRACTOR; SCALED MEASUREMENTS FROM THE DRAWINGS SHALL NOT BE RELIED UPON FOR DETERMINING THE

MAINTENANCE
THE CONTRACTOR SHALL MAINTAIN ALL LANDSCAPED AREAS FOR A PERIOD OF FOUR (4) GROWING MONTHS FROM THE DATE OF SUBSTANTIAL COMPLETION.

MAINTENANCE SHALL INCLUDE: PROPER IRRIGATION TO ENSURE OPTIMUM GROWTH OF TREES, SHRUBS, AND SOD GRASS MOWING TO MAINTAIN AN APPROXIMATE HEIGHT OF 50mm THE CULTIVATION AND WEEDING OF TREE PITS AND PLANTING BEDS INSECT AND DISEASE CONTROL

AT THE END OF THE SPECIFIED MAINTENANCE PERIOD, PROVIDED ALL PLANT MATERIAL IS ALIVE AND IN A HEALTHY GROWING CONDITION, THE OWNER WILL ASSUME THE RESPONSIBILITY OF

PERFORMANCE ACCEPTANCE (SUBSTANTIAL COMPLETION) WRITTEN NOTICE OF PERFORMANCE ACCEPTANCE BY THE LANDSCAPE ARCHITECT FO SUBSTANTIAL COMPLETION OF THE PROJECT LANDSCAPE WORKS SHALL MARK THE START OF THE

SHOULD LOCAL LAW REQUIRE MUNICIPAL ACCEPTANCE. THE LANDSCAPE ARCHITECT WILL SUBMIT THE SUBSTANTIAL COMPLETION CERTIFICATE TO THE MUNICIPALITY SO THAT THEY MAY PROCEED TO INSPECT THE WORK, ISSUE THEIR PERFORMANCE ACCEPTANCE CERTIFICATE, AND REDUCE THE AMOUNT OF SECURITIES.

GUARANTEE
ALL PLANT MATERIAL SHALL BE GUARANTEED FOR TWO (2) YEARS FROM THE DATE ON THE PERFORMANCE ACCEPTANCE CERTIFICATE ISSUED BY THE LANDSCAPE ARCHITECT. PLANTS THAT EXPIRE OR OTHERWISE FAIL TO THRIVE DURING THE GUARANTEE PERIOD SHALL BE REPLACED AT THE EXPENSE OF THE CONTRACTOR.

SIMILARLY, ALL OTHER LANDSCAPE WORK PERFORMED UNDER THIS CONTRACT SHALL BE FULLY GUARANTEED FOR ONE (1) YEAR FROM THE DATE OF PERFORMANCE. ACCEPTANCE BY THE

RIVERWOODS HOMES-(ABAL 3383

COMMON NAME

RIVER BIRCH

COLORADO SPRUCE

ARCADIA JUNIPER

DWARF FALSE SPIREA

ROZANNE CRANESBILL

VARIEGATED PLANTAIN LILY

JAPANESE FOREST GRASS

KARLEY ROSE FOUNTAIN GRASS

DENSE YEM

RED ROCKET RED MAPLE

FRANS FONTAINE HORNBEAM

SKYLINE HONEY-LOCUST

ALL WORK SHALL BE INSPECTED AT THE END OF THE GUARANTEE PERIOD BY THE LANDSCAPE ARCHITECT. ANY DEFICIENCIES SHALL BE RECTIFIED BY THE CONTRACTOR TO THE SATISFACTION OF THE LANDSCAPE ARCHITECT AND THE OWNER. THE LANDSCAPE ARCHITECT WILL THEN ISSUE A

SHOULD LOCAL LAW REQUIRE MUNICIPAL ACCEPTANCE, THE LANDSCAPE ARCHITECT WILL SUBMIT THE FINAL ACCEPTANCE CERTIFICATE TO THE MUNICIPALITY SO THAT THEY MAY PROCEED TO ECT THE WORK, GIVE FINAL APPROVAL, AND RELEASE ALL OUTSTANDING LANDSCAPE

3500mm

--- 2000mm 1000mm 5.B.

In the event of a discrepancy between the planting plan and the plant list quantities, the planting plan shall govern.

EQUAL FORM ----

EQUAL FORM ----

EQUAL FORM ----

MULTI STEM ----

- - - -

SPECIMEN

S.B.

S.B.

S.B.

--- 600mm POTTED MIN. 15 CANDLES 800mm

---- POTTED MIN. 10 STEMS 650mm

---- 600mm POTTED MIN. 15 CANDLES 800mm

---- I gal. POT MIN. 2 YR5. 6TH. 400mm

---- ---- | gal. POT MIN. 2 YRS. 6TH. 400mm

---- I gal. POT MIN. 2 YRS. GTH. 800mm

---- | gal. POT MIN. 2 YRS. 6TH. 400mm

1500mm

MAINTAIN MINIMUM 600 MIDE SOD STRIP BETWEEN PLANTING BED AND CURB UNLESS SPECIFICALLY NOTED OTHERWISE PLANT MINIMUM TWO SHRUBS BETWEEN THE LIMITS OF BET AREA AND SPECIFIED TREE MITHIN THE BED MAINTAIN EQUAL GEOMETRIC SPACING FOR EACH SPECIES AS NOTED IN THE PLANT LIST MAINTAIN MINIMUM 1000 SETBAC FOR TREE TRUNK FROM CURB TO ALLOW FOR CAR OVERHANG PLANT LOCATIONS BETWEEN CONFERS MAY VARY FROM THE ESTABLISHED GEOMETRIC PATTERN IN THE BED TYPICAL SHRUB DO NOT GROWD PLANTS. SHRUB BRANCHES AND CONIFERS

TYPICAL PLANTING LAYOUT SYMBOLS REPRESENT INSTALLED PLANT SIZE

SHRUB HEIGHT SHALL BE

MEASURED FROM FINISHED GRADE TO UPPER MAIN MASS

SHRUBS PLANTED IN GROUPS

SHALL BE SET IN CONTINUOUS

SET SHRUBS 50mm HIGHER THAN

ADJACENT FINISHED GRADE TO

PLANTING METHOD ILLUSTRATED

APPLIES EQUALLY TO BARE ROOT,

POTTED OR B&B NURSERY STOCK

SCARIFY, IRRIGATE AND FERTILIZE

EXCAVATE AND PREPARE PLANTING

TYPICAL INSTALLATION

SHRUB PLANTING DETAIL

BED TO MINIMUM 500mm DEPTH AS SPECIFIED

THE INSIDE OF SHRUB BED

PRIOR TO PLANTING

BEDS AS SHOWN ON PLAN

ALLOW FOR SETTLEMENT

FINISHED GRADE

ALL DIMENSIONS ARE GIVEN IN MILLIMETERS ABAL P401-940528

PRUNING SHALL BE

LIMITED TO DEAD OR

BROKEN BRANCHES

AFTER PLANTING.

MAINTAIN ORIGINA

SHAPE OF SHRUB DO

NOT TRIM LEADER

COVER WITH 75mm

ENTIRE BED AREA

APPROVED SHREDDED

SPECIFIED SOIL MIXTURE

FIRMLY COMPACTED TO

ELIMINATE AIR POCKETS

AND PREVENT SETTLEMENT


REMOVE NURSERY POTS OR

WRAP PRIOR TO PLANTING

COMPACTED SUBGRADE

NTS

ABAL P301-040305

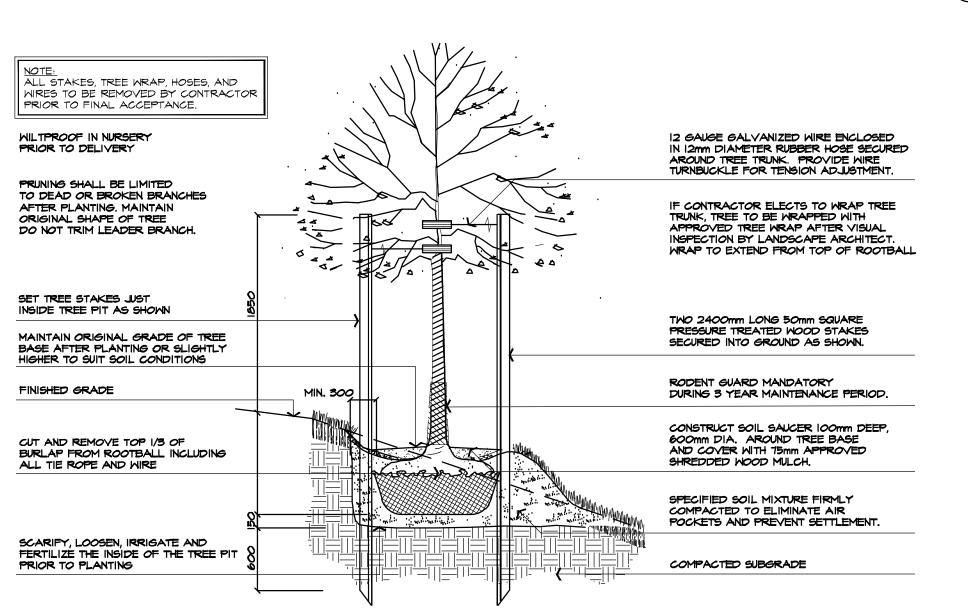

GENERAL NOTES

ADJUST BED SIZE TO SUIT PLANT GUANTITIES

ENSURE SOD DOES NOT ENCROACH MINIMUM SETBACK DIMENSIONS

DECIDUOUS TREE PLANTING ON SLOPE DETAIL

TOPSOIL AND SOD DETAIL TOWN OF WASAGA BEACH STANDARD DETAIL

NOTES

ALL STAKES, TREE WRAP, HOSES, AND 12mm DIAMETER BLACK RUBBER WIRES TO BE REMOVED BY CONTRACTOR HOSE LOOPED ABOVE FIRST STRONG BRANCH PRIOR TO FINAL ACCEPTANCE. WILTPROOF IN NURSERY 12 GAUGE GALVANIZED WIRE PRIOR TO DELIVERY ENCLOSED IN 12mm DIAMETER RUBBER HOSE SECURED AROUND TREE TRUNK. PROVIDE WIRE PRUNING SHALL BE LIMITED TO DEAD OR BROKEN BRANCHES TURNBUCKLE FOR TENSION AFTER PLANTING. MAINTAIN original shape of tree DO NOT TRIM LEADER BRANCH. WRAP TREE TRUNK WITH APPROVED TREE WRAP AFTER VISUAL INSPECTION BY LANDSCAPE ARCHITECT. WRAP TO SET TREE 50mm HIGHER THAN ADJACENT FINISHED GRADE TO ALLOW FOR SETTLEMENT EXTEND FROM TOP OF ROOTBALL TO ABOVE GUYWIRE HOSE LOCATION. PROVIDE MIN. IOMM OVERLAP. SET TREE STAKES JUST INSIDE TREE PIT AS SHOWN TWO 2400mm LONG 50mm SQUARE PRESSURE TREATED WOOD STAKES SECURED INTO GROUND AS SHOWN FINISHED GRADE PROVIDE APPROVED RODENT GUARD WHERE REQUIRED CUT AND REMOVE TOP 1/3 OF BURLAP FROM ROOTBALL INCLUDING CONSTRUCT LOOMM SOIL SAUCER AROUND TREE BASE AND COVER WITH 15mm APPROVED SHREDDED ALL TIE ROPE AND WIRE WOOD MULCH SCARIFY, IRRIGATE AND FERTILIZE SPECIFIED SOIL MIXTURE FIRMLY PRIOR TO PLANTING COMPACTED TO ELIMINATE AIR POCKETS AND PREVENT SETTLEMENT PROVIDE 75mm SOIL MOUND AT BASE OF PIT AS SHOWN COMPACTED SUBGRADE

DECIDUOUS TREE PLANTING DETAIL TYPICAL INSTALLATION FOR 75mm CALIPER TREES OR LESS

NTS ABAL PIOI-051027

ALL STAKES, TREE WRAP, HOSES, AND WIRES TO BE REMOVED BY CONTRACTOR PRIOR TO FINAL ACCEPTANCE. SECURE STAKES TO MAIN TREE TREE SHALL BE MEASURED TO TRUCK WITH BURLAP ROPE. HEIGHT OF LAST YEARS GROWTH ENSURE THAT THE STAKES DO NOT CONTACT EXPOSED TREE BARK PRUNING SHALL BE LIMITED TO DEAD OR BROKEN BRANCHES AFTER PLANTING. MAINTAIN ORIGINAL SHAPE OF TREE THREE 50mm SQUARE PRESSURE DO NOT TRIM LEADER BRANCH. TREATED WOOD STAKES SECURED INTO GROUND A MINIMUM OF SET TREE 50mm HIGHER THAN 45mm AS SHOWN ADJACENT FINISHED GRADE TO ALLOW FOR SETTLEMENT CONSTRUCT IOOMM SOIL SAUCER AROUND TREE BASE AND COVER WITH IOOMM APPROVED SHREDDED WOOD MULCH SET TREE STAKES JUST INSIDE TREE PIT AS SHOWN SPECIFIED SOIL MIXTURE FIRMLY COMPACTED TO ELIMINATE AIR POCKETS AND PREVENT SETTLEMENT SCARIFY, IRRIGATE AND FERTILIZE THE INSIDE OF THE TREE PIT PRIOR TO PLANTING CUT AND REMOVE TOP 1/3 OF BURLAP FROM ROOTBALL INCLUDING ALL TIE ROPE AND WIRE PROVIDE 75mm SOIL MOUND AT BASE OF PIT AS SHOWN COMPACTED SUBGRADE

マスクト さくさくさい さくさく さくさくしょく きんきりく しんりんしんしん

1. SOD MUST FINE FESCUEZKEN WORM BILLEGRASS AS SPECIFIED BY THE

2. TOPSOIL MUST BLILL STILL AND AN AGRONOMY KLPORT PREPARED BY AN ACCRECITED LABORATORY CONFIRMING THE SUITABILITY OF THE TOPSOL

3. TOPSOIL MUST BE COMPLETELY CLEAR OF ALL STONES IN EXCESS OF

4. THE SUB GRADE MUST BE GRADED TO ENSURE CONSISTENT TOPSOIL THICKNESS AND PROVIDE POSITIVE SURFACE CRAINAGE.

5. A PRE-SOC INSPECTION IS REQUIRED TO BE COMPLETED BY THE TOWN ENGINEER PRIOR TO THE PLACEMENT OF TOPSOIL.

NURSERY SOD GROWERS ASSOCIATION OF ONTARIO.

AND RECOMMENDATIONS -CR FERTL ZATION.

25mm, DEBRIS, AND WOODY MATERIAL.

CONIFEROUS TREE PLANTING DETAIL TYPICAL INSTALLATION FOR 2000mm HEIGHT TREES OR LESS

ABAL P201-051027

FINE FESCUE/KENTUCKY BLUECRASS

45-70% 1-20% 0 30%

MATLRIAL: 4-5%

NURSERY SOD

- SUB-CRADE

TOWN OF WASAGA BEACH


TOPSOIL & SOD

REQUIREMENTS

SCALE: N.T.S.

DRAWN: TVM

ESIGN: MUP CRED: MJP project

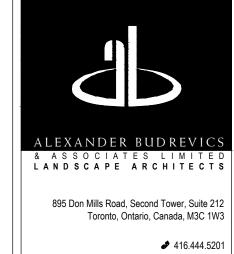

by

www.budrevics.com

WASAGA BEACH, ON

RIVERWOODS HOMES RIVER ROAD WEST

WASAGA RIVERWOODS HOMES INC.

ISSUED FOR APPROVAL

JUN 31 | ISSUED FOR CLIENT REVIEW

ISSUED FOR FOURTH SPA SUBMISSION

ISSUED FOR SECOND SPA SUBMISSION

ISSUED FOR ZONING & SPA SUBMISSION

version

All information hereon to be checked and verified at the site and any

discrepancies must be reported to and clarified by the landscape architect

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ISSUED FOR THIRD SPA SUBMISSION

2024

JAN 18

2023

NOV 22

2022

DEC 7

2021

2020

2020

no. date

drawing

PLANTING DETAILS

date JUNE 4 , 2020	drawn RS
scale* AS SHOWN	file 3383 D1 V6-240508
direction	project no.
	3383


NOTED SCALE IS APPLICABLE ONLY WHEN PRINTED ON ARCH D (24"x36") SIZE SHEET

NTS ABAL P303-051027




SMING MANUFACTURER: JAMBETTE

> PRODUCT: ETNA TRAPP-I - GX-07069 COLOUR: TO BE APPROVED BY CLIENT & LANDSCAPE ARCHITECT PRIOR TO ORDERING TOPSOIL AND SOD

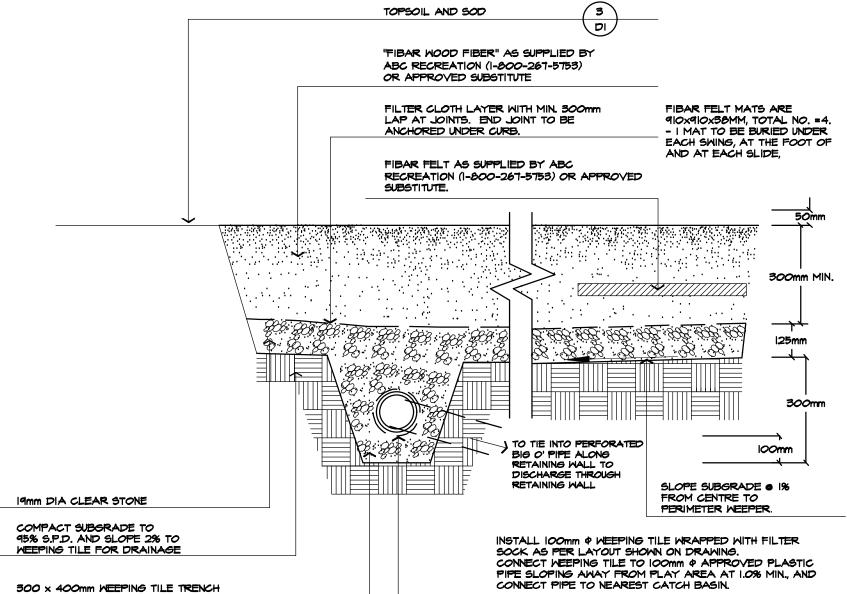

PLAY AREA WITH FIBRE SURFACE DETAIL ABAL CI05x-220617

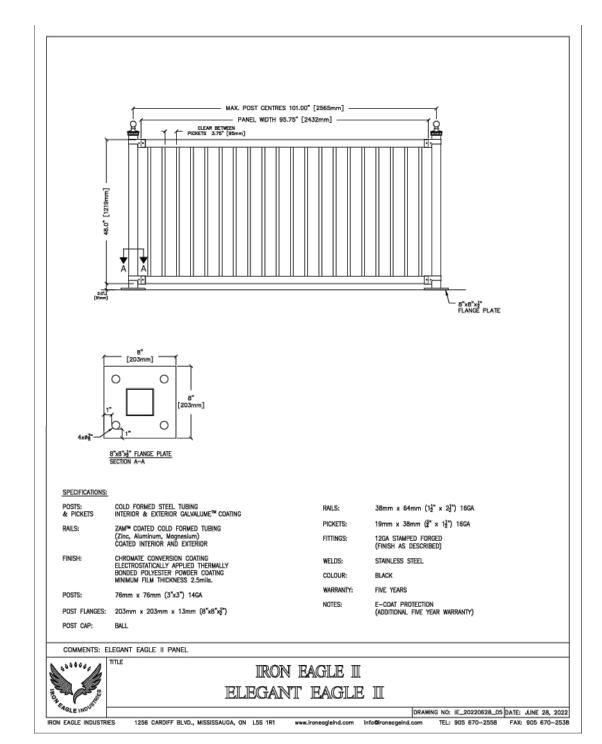


DECORATIVE METAL FENCE MANUFACTURER: IRON EAGLE


PRODUCT: ELEGANT EAGLE II

HEIGHT: 1200 MM

COLOUR: TO MATCH BUILDING FEATURES OR BLACK POWDERCOAT

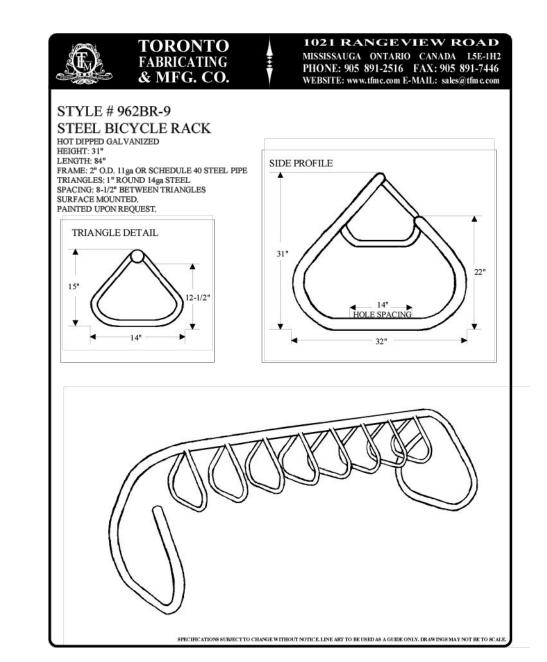


BIKE RACK NTS MANUFACTURER: TORONTO FABRICATING & MFG. CO. PRODUCT: 962BR-9 GALYANIZED FINISH: QUANTITY: TWO (2) OR APPROVED SUBSTITUTE

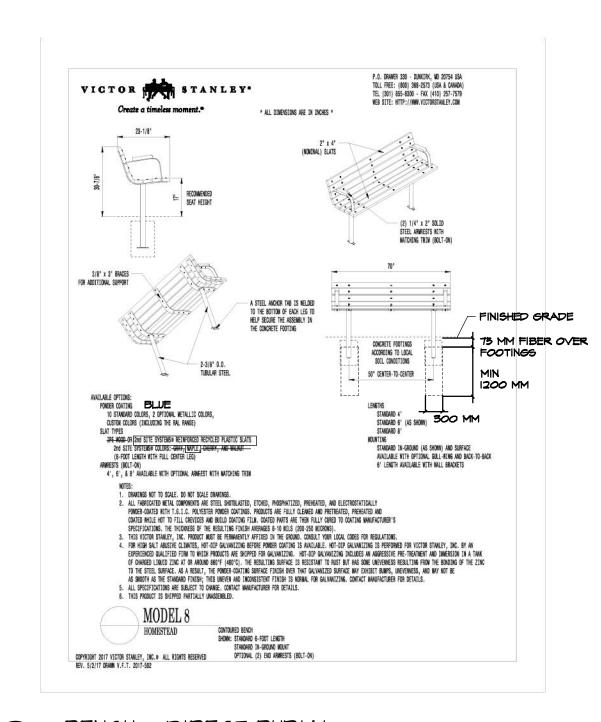

BENCH - DIRECT BURIAL NTS MANUFACTURER: VICTOR STANLEY PRODUCT: MODEL & CONTOURED BENCH MATERIAL: REINFORECED RECYCLED PLASTIC SLATS COLOUR: TO MATCH PLAY STRUCTURE - TO BE APPROVED BY CLIENT & LANDSCAPE ARCHITECT PRIOR TO ORDERING OR APPROVED SUBSTITUTE




PLAY STRUCTURE MANUFACTURER: JAMBETTE PRODUCT: PLAYSTRUCTURE - J3-22310-5HA COLOUR: TO BE APPROVED BY CLIENT & LANDSCAPE ARCHITECT PRIOR TO ORDERING

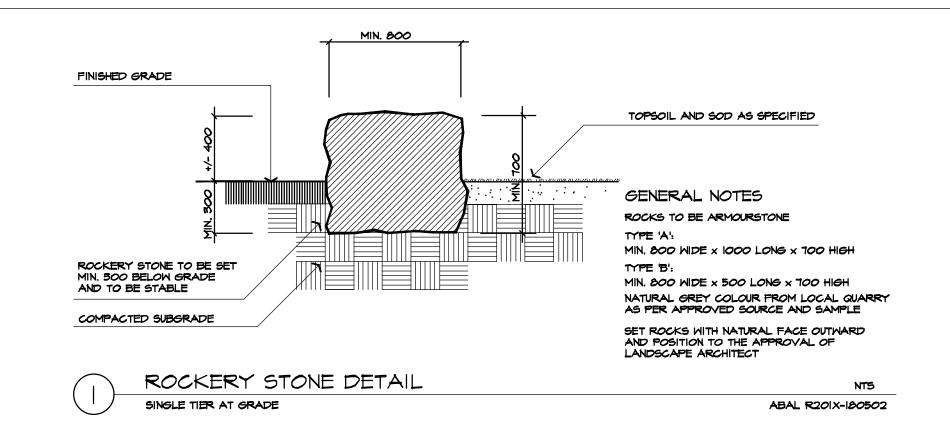

52 MPA POURED CONCRETE -EXPANSION JOINTS EVERY 6000mm, CONTROL JOINTS EVERY 1500mm, BROOM FINISH AND TROWEL JOINTS UNLESS OTHERWISE SPECIFIED. INSTALL 19mm EXPANSION JOINTS ADJACENT TO CONCRETE CURBS AND BUILDING WALLS AS REQUIRED. 150 x 150mm WELDED WIRE MESH MIN. 50mm COVER ALL AROUND OR FIBER MIXTURE CONCRETE FINISHED GRADE GRANULAR 'A' BASE COMPACTED TO 98% S.P.D. SUBGRADE MATERIAL COMPACTED TO 95% S.P.D.

CONCRETE WALKWAY DETAIL NTS TYPICAL INSTALLATION ABAL H201-000529

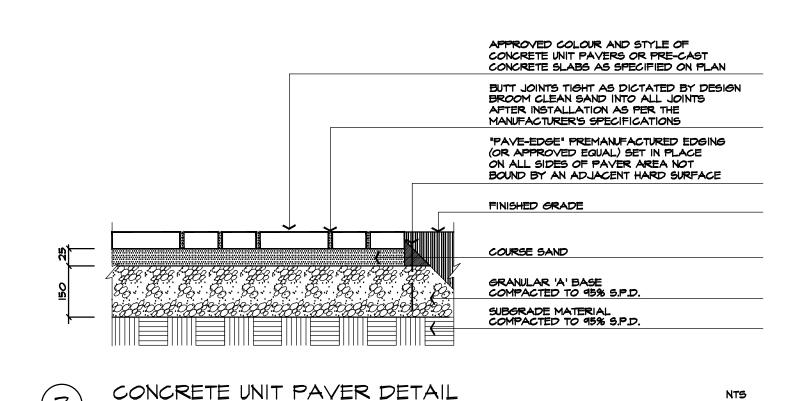

TYPICAL INSTALLATION




ABAL H301-070613

WOOD SCREEN DETAIL

MAY 8	MAY 8	ISSUED FOR APPROVAL	AV
6 2024		135GLD I OK AI I KOVAL	
5	JAN 18	ISSUED FOR FOURTH SPA SUBMISSION	AV/
3	2023	1350ED FOR FOURTH SFA SUBMISSION	НН
,	NOV 22	ISSUED FOR THIRD SPA SUBMISSION	AV/
4	2022	135UED FOR THIRD SPA SUBMISSION	ED
2	DEC 7	ISSUED FOR SECOND SPA SUBMISSION	SO
3 2021		135UED FOR SECOND SPA SUBMISSION	/LB
AUG 21		ISSUED FOR ZONING & SPA SUBMISSION	RS
2 2020		ISSUED FOR ZOINING & SPA SUBMISSION	
1 1	JUN 31	ICCLIED FOR CLIENT DEVIEW	LK
	2020	ISSUED FOR CLIENT REVIEW	/RS
no.	date	version	

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project

RIVERWOODS HOMES RIVER ROAD WEST

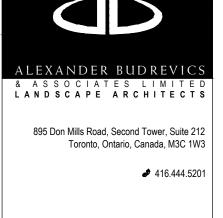WASAGA BEACH, ON


WASAGA RIVERWOODS HOMES INC.

drawing

LANDSCAPE DETAILS

date JUNE 4 , 2020	drawn RS	
scale* AS SHOWN	file 3383 D2 V6-240508	
direction	project no.	
	3383	
	sheet no.	
	D-2	

*NOTED SCALE IS APPLICABLE ONLY WHEN PRINTED ON ARCH D (24"x36") SIZE SHEET

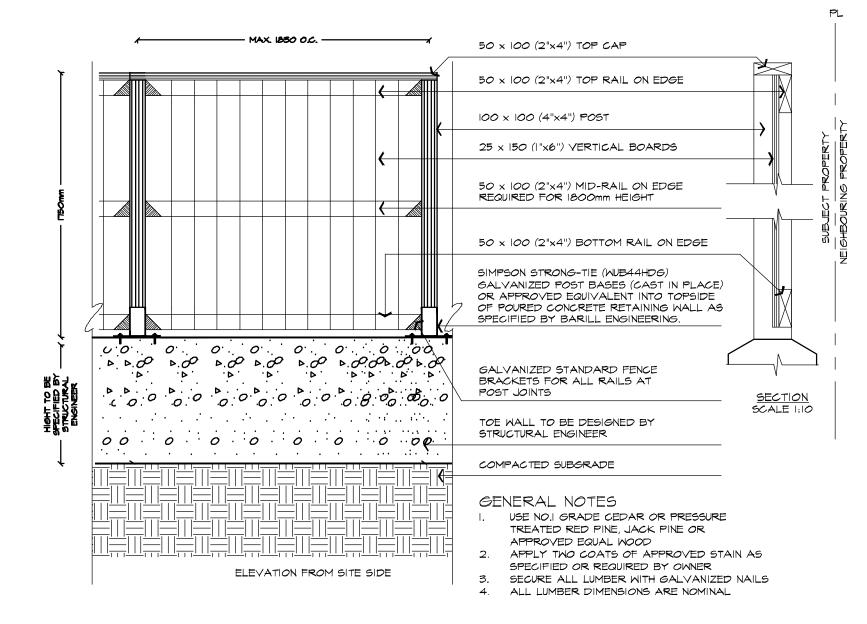

WOOD PRIVACY FENCE DETAIL

WALL ATTACHMENT TO BE SPECIFIED BY STRUCTURAL ENG.
SHOP DRAWINGS TO BE APPROVED PRIOR TO MANUFACTURING

SCALE 1:25

ABAL F301Ax-240508

6	MAY 8	ISSUED FOR APPROVAL	
	2024	133GLD I OK AI I KOVAL	
5	JAN 18	ISSUED FOR FOURTH SPA SUBMISSION	
3	2023	135UED FOR FOURTH SFA SUBMISSION	HH
4	NOV 22	ISSUED FOR THIRD SPA SUBMISSION	AV/
	2022	ISSUED FOR THIRD SPA SUBMISSION	
3	DEC 7	ISSUED FOR SECOND SPA SUBMISSION	SO
3	2021	135UED FOR SECOND SPA SUBMISSION	/LB
2	AUG 21	ISSUED FOR ZONING & SPA SUBMISSION	RS
	2020		/AV
1	JUN 31	ICCLIED FOR CLIENT DEVIEW	LK
	2020	ISSUED FOR CLIENT REVIEW	
no.	date	version	by

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RIVERWOODS HOMES


RIVER ROAD WEST Wasaga Beach, on


WASAGA RIVERWOODS HOMES INC.

drawing

LANDSCAPE DETAILS

file 3383 D2 V6-240508 project no.
project no.
3383
sheet no.
D-3

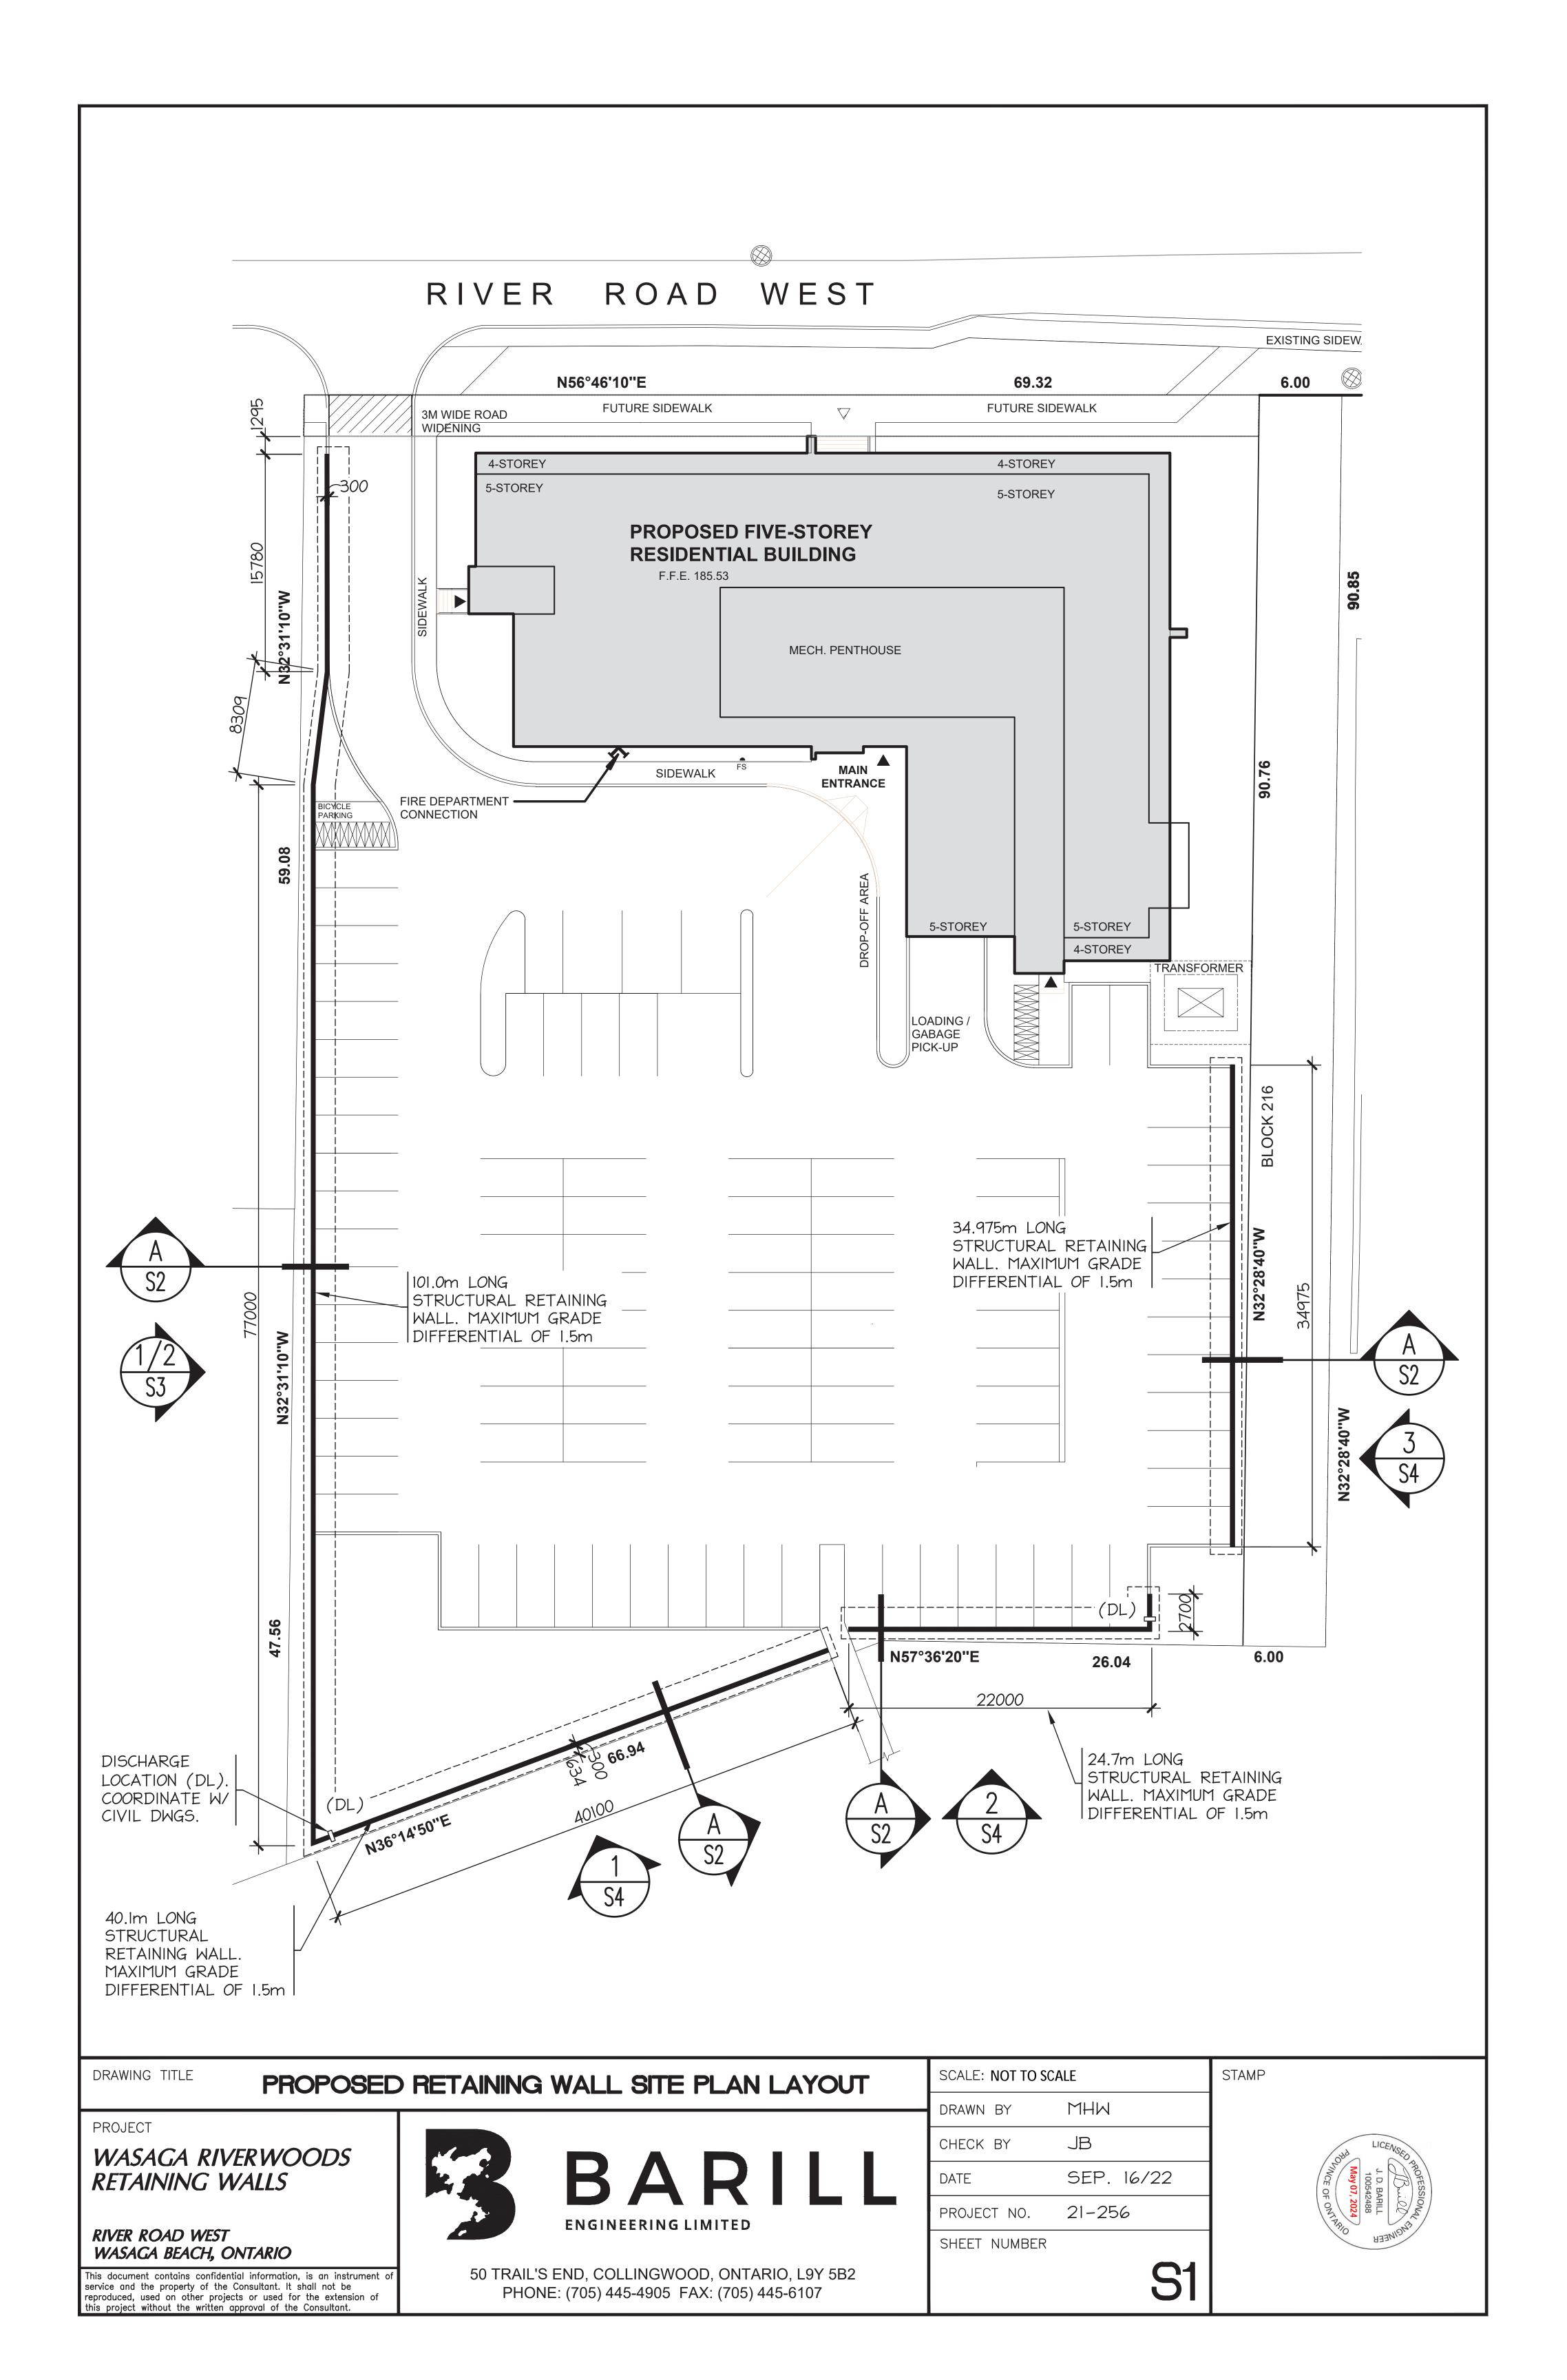

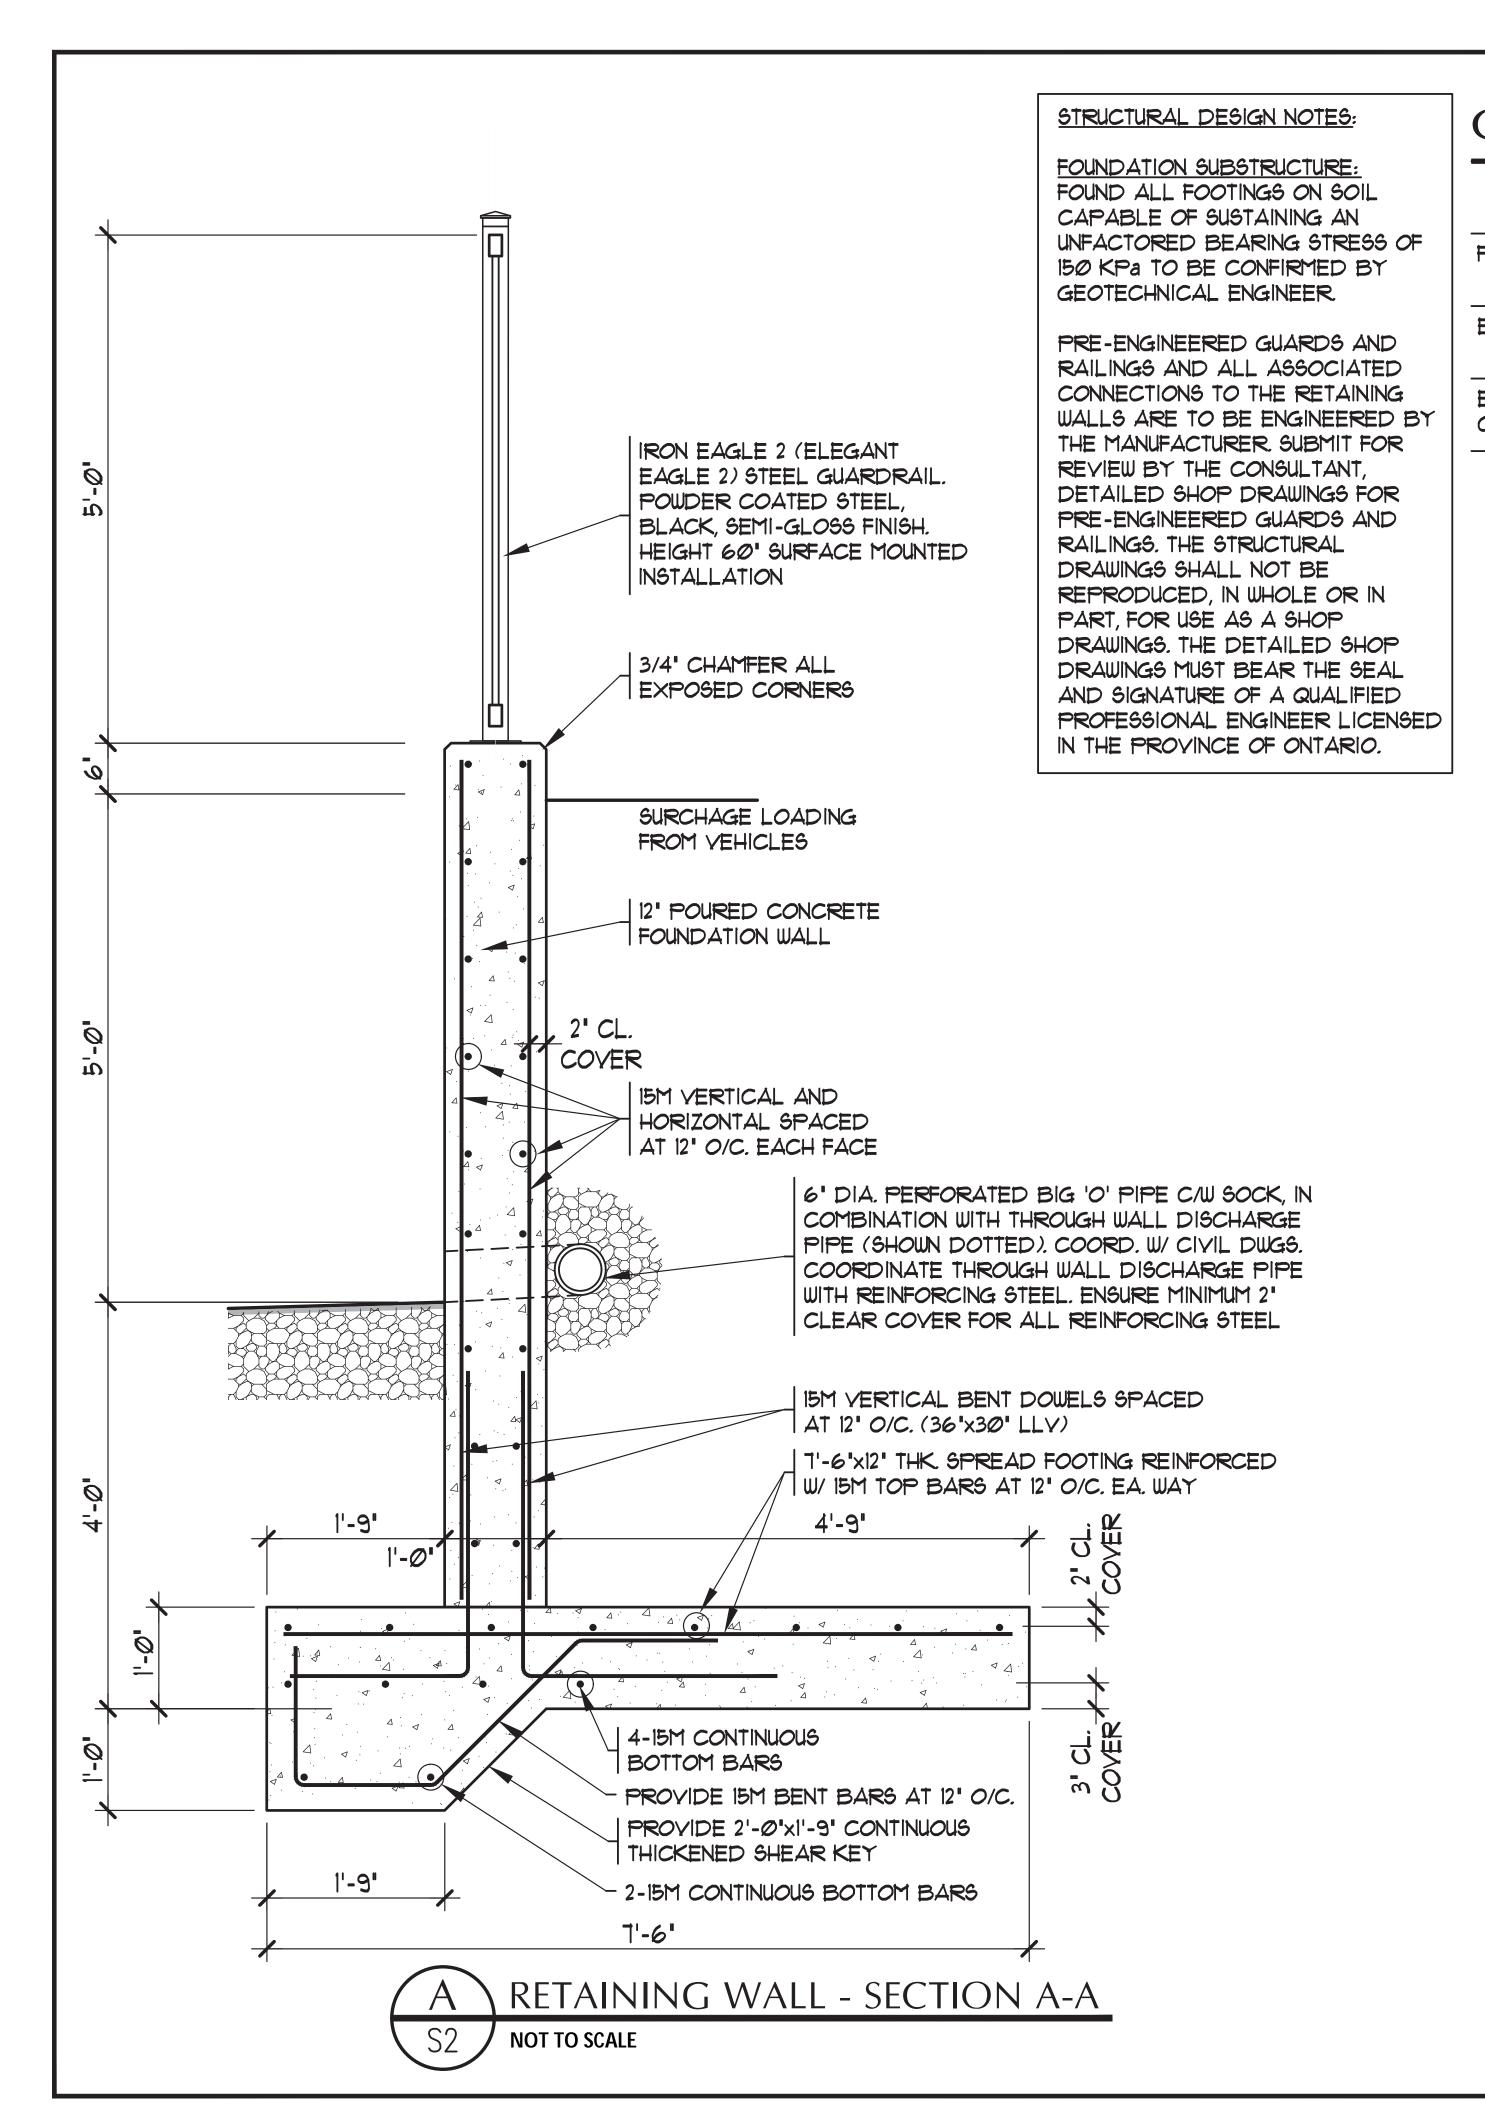

CONCRETE MIX SCHEDULE

	STRENGTH AT 28 DAYS (MPa)	SLUMP AT DELIVERY (mm)	AIR ENTRAINMENT	MAXIMUM W/C RATIO	EXPOSURE CLASSIFICATION
FOOTINGS	2Ø	8Ø +/- 2Ø		to suit	N
EXTERIOR WALLS	3Ø	80 +/- 20	5-8%	to suit	F-2
EXTERIOR SIDEWALKS, CURBS AND APRON SLABS	32	8Ø +/- 2Ø	5-8%	<i>0.</i> 45	C-2



ICENSE	J. D. BARILL	STONEER
TAR.	100542488 May 07, 2024) ~
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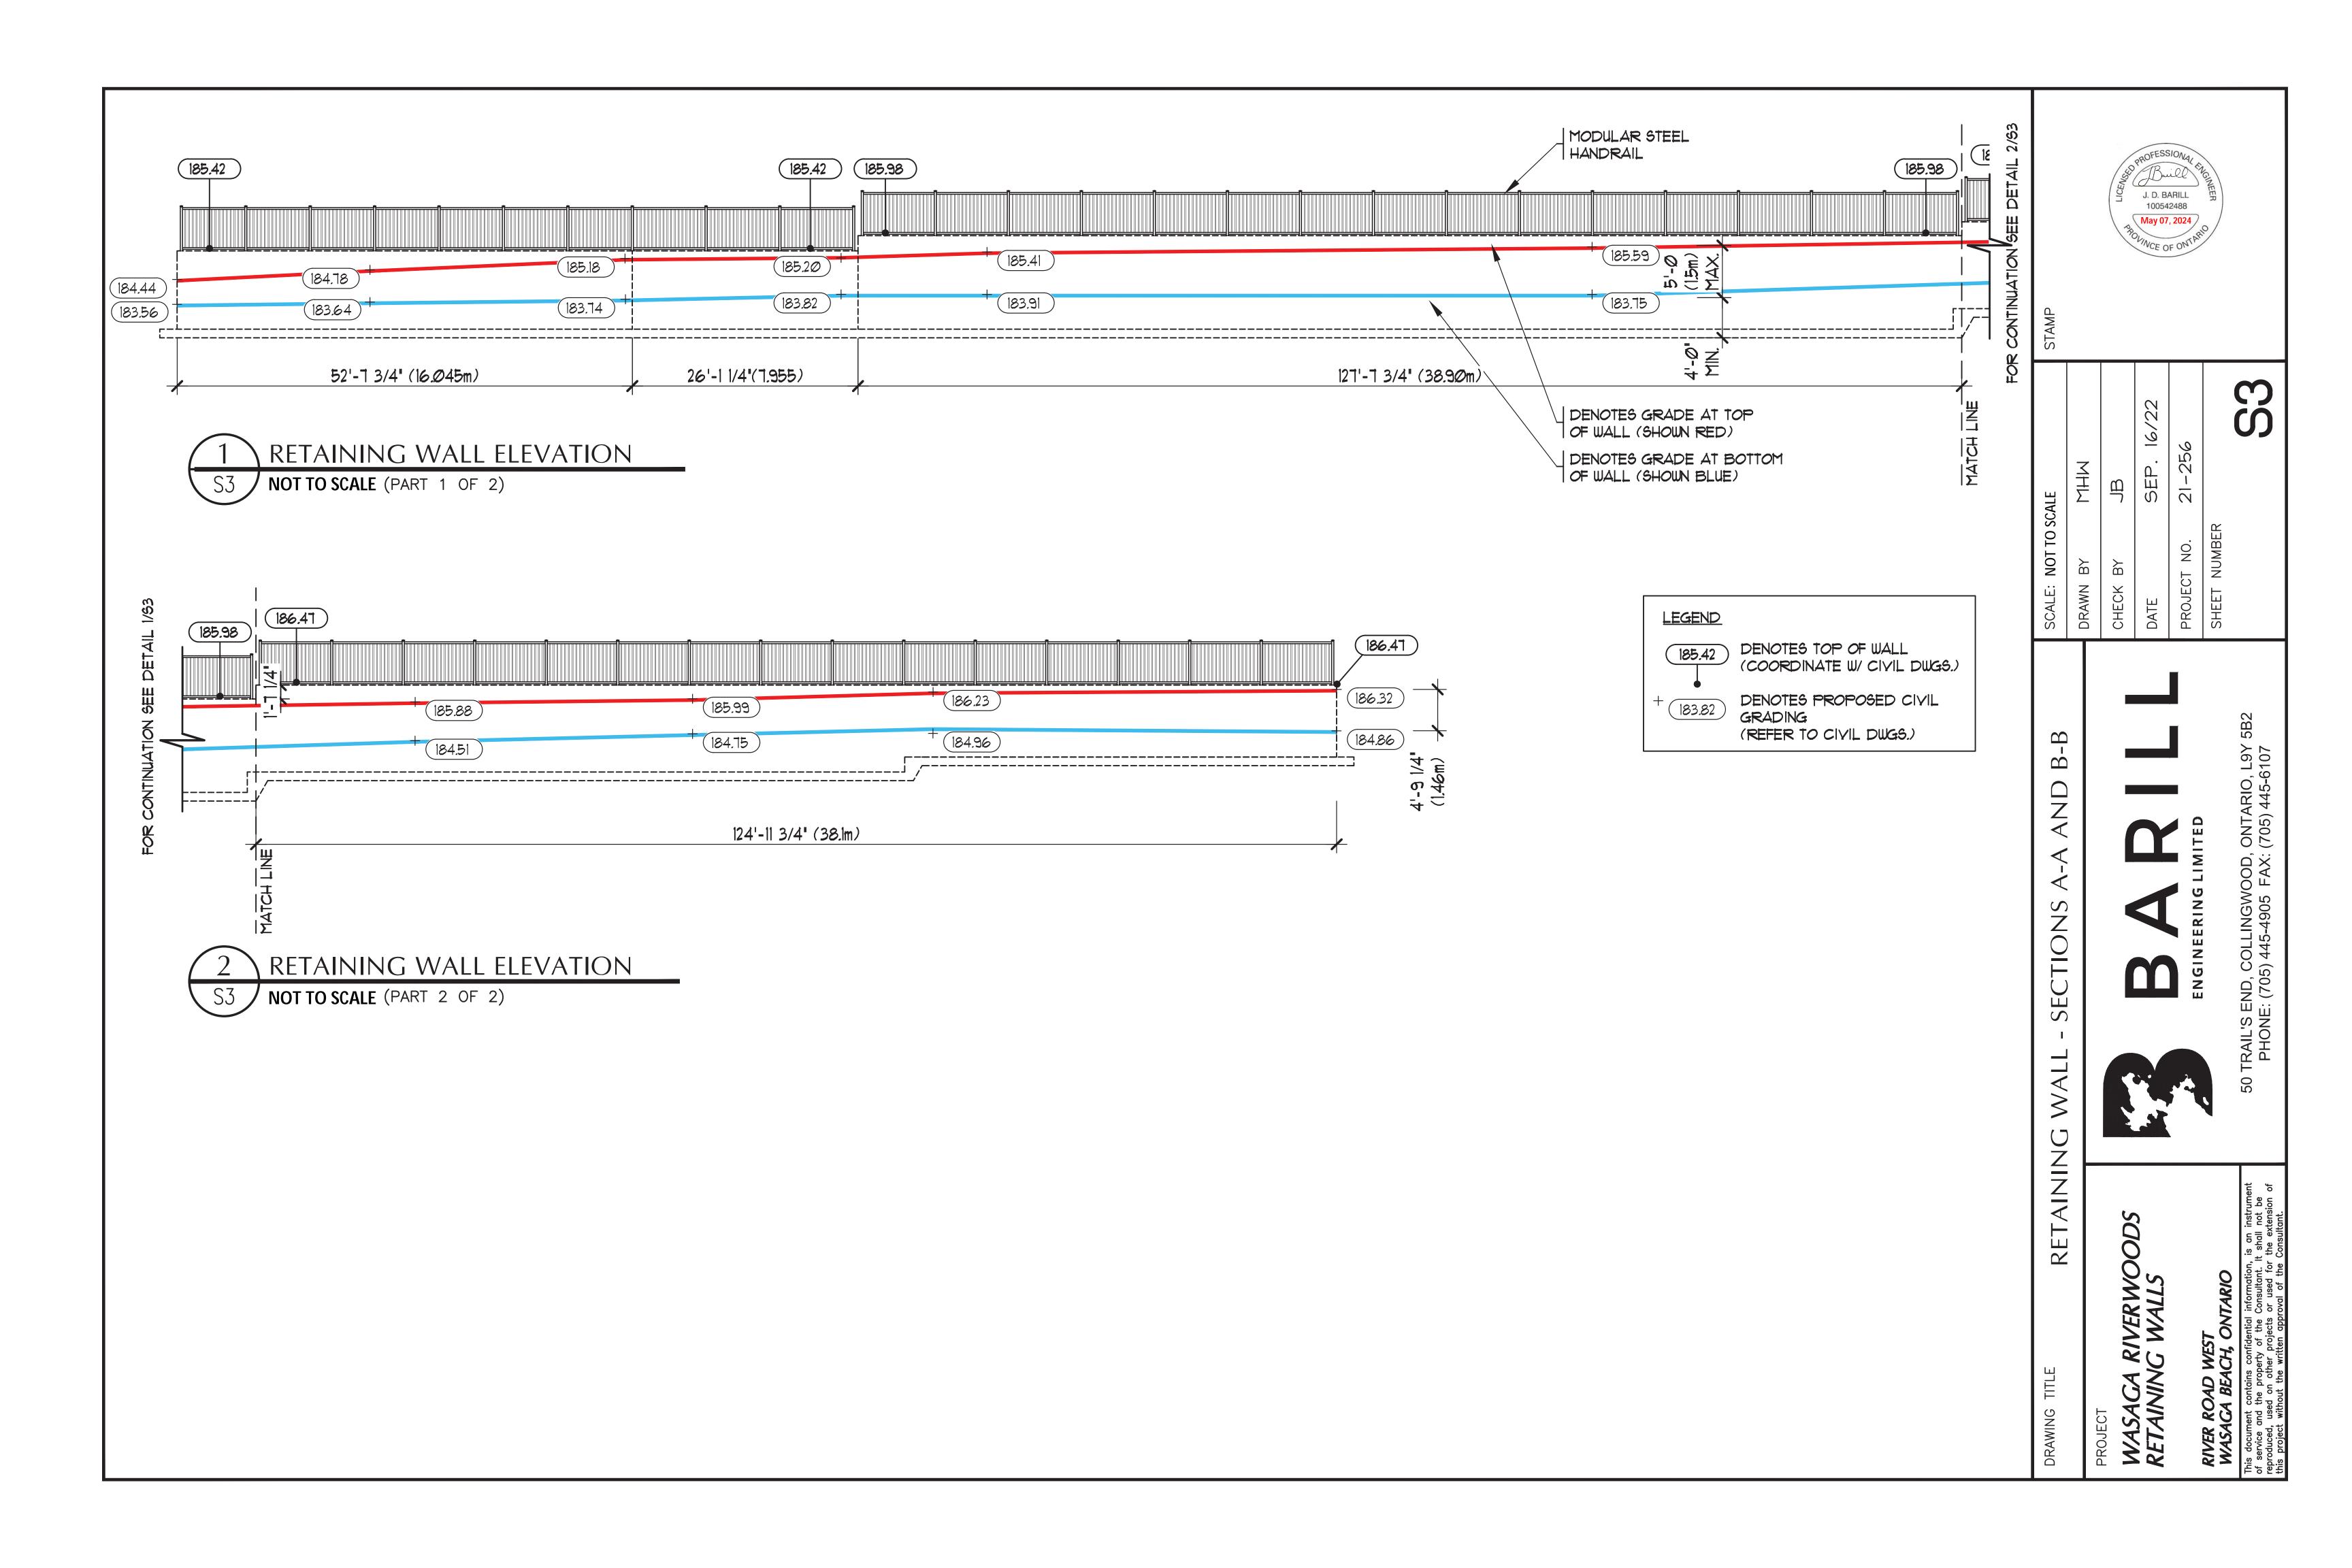
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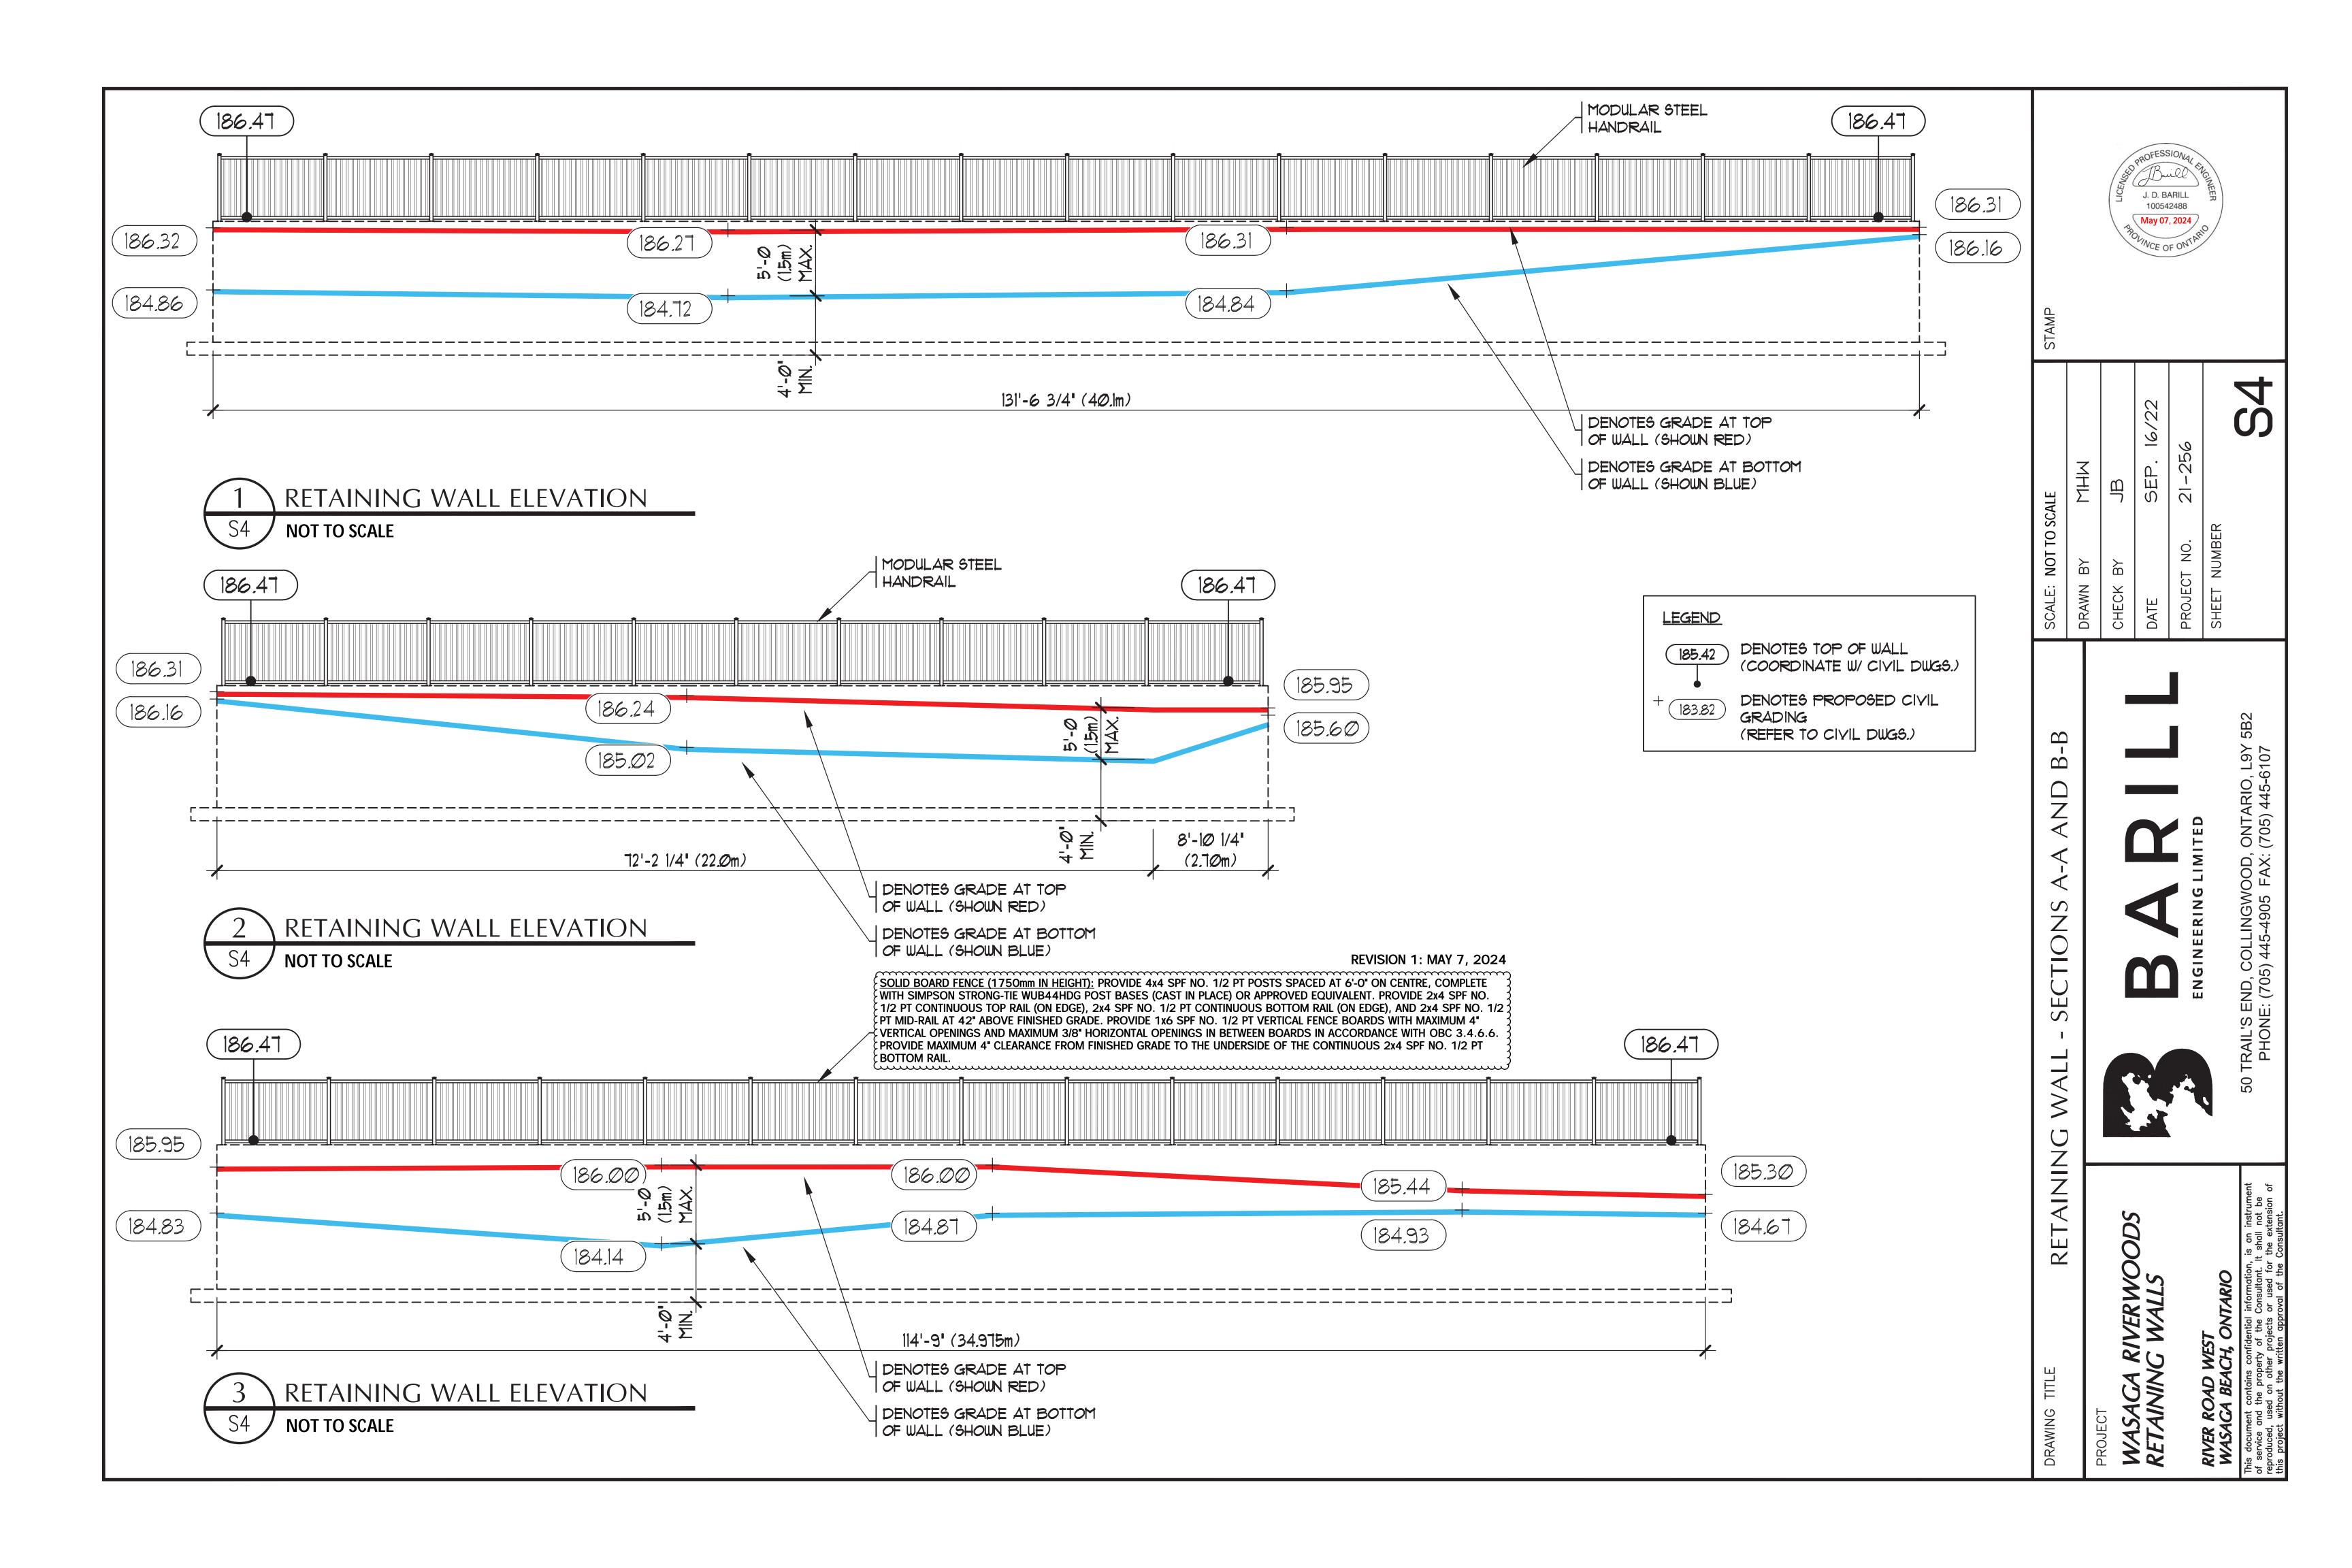




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STRUCTURAL NOTES

A. GENERAL

- WHERE DOCUMENTS ARE REFERENCED IN THE GENERAL AND DESIGN NOTES, THEY SHALL BE THE LATEST EDITIONS OR REVISION, UNLESS NOTED OTHERWISE.
- READ STRUCTURAL DOCUMENTS IN CONJUNCTION WITH ARCHITECTURAL, MECHANICAL, ELECTRICAL, AND OTHER CONTRACT DOCUMENTS.
- BEFORE PROCEEDING WITH THE WORK, CHECK ALL DIMENSIONS SHOWN ON THE STRUCTURAL DOCUMENTS WITH SITE CONDITIONS AND THOSE SHOWN ON THE ARCHITECTURAL, MECHANICAL AND ELECTRICAL DOCUMENTS AND REPORT DISCREPANCIES TO THE CONSULTANT.
- CARRY OUT CONSTRUCTION OPERATIONS, INCLUDING THE INSTALLATION OF TEMPORARY GUYING AND SHORING REQUIRED, ENSURING THAT THE EXISTING STRUCTURE OR MEMBERS ALREADY ERECTED ARE NOT LOADED IN EXCESS OF THEIR SAFE LOAD CARRYING CAPACITY.

REFERENCE STANDARDS/CODES AND ACTS

- CONFORM WITH THE ONTARIO REGULATION 332/12, AND ANY APPLICABLE ACTS OF ANY AUTHORITY HAVING JURISDICTION, AND THE FOLLOWING:
 - 1.1 CAN/CSA A23.1 CONCRETE MATERIALS AND METHODS OF CONCRETE CONSTRUCTION.
 - 1.2 CAN/CSA A23.2 METHODS OF TEST FOR CONCRETE.
 - 1.3 CAN/CSA A23.3 DESIGN OF CONCRETE STRUCTURES
 - 1.4 CAN/CSA-S16 LIMIT STATES DESIGN OF STEEL STRUCTURES.
 - 1.5 RSIC REINFORCING STEEL INSTITUTE OF CANADA (RSIC), MANUAL OF STANDARD PRACTICE.
 - 1.6 S136 COLD FORMED STEEL STRUCTURAL MEMBERS.
 - 1.7 CAN/CSA G40.20/G40.21 STRUCTURAL QUALITY STEEL
- 2. ALL STANDARDS AND PUBLICATIONS REFERENCED BY THE STANDARDS NOTED ABOVE ARE TO APPLY.
- WHERE THERE ARE DIFFERENCES BETWEEN THE DOCUMENTS AND THE STANDARDS, CODES AND ACTS, THE MOST STRINGENT SHALL GOVERN.

C. QUALIFICATIONS

ANY ORGANIZATION UNDERTAKING TO WELD UNDER THIS CONTRACT SHALL BE CERTIFIED BY THE CANADIAN WELDING BUREAU UNDER REQUIREMENTS OF DIVISION 1 OR DIVISION 2.1 OF W47.1.

D. <u>SUBMITTALS</u>

SHOP DRAWINGS

- 1.1. SUBMIT FOR REVIEW BY THE CONSULTANT, <u>DETAILED</u> SHOP DRAWINGS FOR ALL TEMPORARY AND PERMANENT STRUCTURAL AND ARCHITECTURAL WORK INCLUDING BUT NOT LIMITED TO: PRE-ENGINEERED STRUCTURAL STEEL OR ALUMINUM
- 1.2. THE SCALE OF THE DRAWINGS SHALL BE SUCH THAT THE DETAILS OF THE STRUCTURAL WORK ARE CLEARLY SHOWN, AND IN NO CASE SMALLER THAN 1:50 (1/4" = 1'0").
- 1.3. THE STRUCTURAL DRAWINGS SHALL NOT BE REPRODUCED, IN WHOLE OR IN PART, FOR USE AS SHOP DRAWINGS.
- 1.4. EACH DRAWING SUBMITTED FOR PRE-ENGINEERED STRUCTURAL STEEL OR ALUMINUM GUARDRAILS SHALL BEAR THE SEAL AND SIGNATURE OF A QUALIFIED PROFESSIONAL ENGINEER LICENSED IN THE PROVINCE OF ONTARIO.
- 1.5. CONTRACTOR SHALL ALLOW FOR A 5 WORKING DAY TURN AROUND TIME FOR STRUCTURAL CONSULTANT TO REVIEW THE SHOP DRAWINGS.

CONCRETE MIX DESIGNS

- 2.1. SUBMIT ALL CONCRETE MIX DESIGNS FOR REVIEW.
- 2.2. DESCRIBE IN DETAIL ON THE MIX DESIGN SUMMARY THE LOCATION(S) WHERE EACH MIX IS TO BE PLACED IN THE STRUCTURE.

AS-BUILT DRAWINGS

3.1. MARK ON A COMPLETE SET OF REPRODUCIBLE AS-BUILT DRAWINGS ANY CHANGES ADDITIONS, OR DELETIONS THAT OCCUR DURING CONSTRUCTION AS A RESULT OF THE CONTRACTOR'S WORK, CHANGE OF ORDERS OR FOR ANY OTHER REASON.

MATERIALS

- PROVIDE ONLY NEW STRUCTURAL MATERIALS IN ACCORDANCE WITH THE REFERENCE STANDARDS AND THE FOLLOWING, UNLESS OTHERWISE NOTED.
- 1.1. CONCRETE: CONFORM TO THE REQUIREMENTS OF CSA-A23.1 AND THE FOLLOWING:
- 1.1.1. EXPOSED TO FREEZE-THAW & CHLORIDES (EXPOSURE CLASS C-1): f'c = 35MPa.
- 1.1.2. EXPOSED TO FREEZE-THAW (EXPOSURE CLASS F-1): f'c = 30MPa.
- 1.1.3. NOT EXPOSED: f'c = 25MPa.
- 1.2. REINFORCEMENT: CONFORM TO CSA G30 SERIES, FY=400MPa FOR ALL REINFORCEMENT. ALL REINFORCEMENT IS TO BE BLACK EXCEPT WHERE THE SUFFIX C IS USED TO DESIGNATE EPOXY COATED REINFORCEMENT.
- 1.3. ANCHOR BOLTS: GRADE A307 OR 300W THREADED ROD CONFORMING TO CSA G40.21-M.
- 1.4. NON-SHRINK GROUT = PREMIXED COMPOSITION OF NON METALLIC AGGREGATE, CEMENT, WATER REDUCING AND PLASTICIZING AGENTS, OF FLOWABLE CONSISTENCY AND CAPABLE OF ACHIEVING A COMPRESSIVE STRENGTH AT 28 DAYS OF AT LEAST 35 MPa (5 ksi).
- 1.5. FOUNDATION INSULATION: EXTRUDED POLYSTYRENE WITH A MINIMUM COMPRESSIVE STRENGTH OF 0.24 MPA UNLESS NOTED OTHERWISE

F. EXECUTION

FOUNDATIONS

- 1.1. A COPY OF THE SOIL INVESTIGATION REPORT BY SOIL ENGINEERS LIMITED DATED MAY 203.5
- 1.2. 14 IS AVAILABLE FROM THE CONSULTANT. READ THE REPORT, VISIT THE SITE AND THOROUGHLY FAMILIARIZE YOURSELF WITH ALL SURFACE AND SUBSURFACE CONDITIONS. THIS INFORMATION IS GIVEN SOLELY AS A GUIDE. NO RESPONSIBILITY IS ACCEPTED BY THE OWNER OR THE CONSULTANT FOR IT'S CORRECTNESS, NOR SHALL IT'S ACCURACY OR ANY OMISSIONS AFFECT THE PROVISION OF THIS CONTRACT.
- 1.3. FOUND ALL FOOTINGS ON SOIL CAPABLE OF SUSTAINING AN UNFACTORED BEARING STRESS OF 150 kN/m2 (3000 psf).
- 1.4. FOUND ALL FOOTINGS WHICH WILL BE EXPOSED TO FROST ACTION IN THE COMPLETED BUILDING A MINIMUM OF 1200mm (4'-0") BELOW FINISHED GRADE.
- 1.5. DO NOT EXCEED A RISE OF 7 IN A RUN OF 10 IN THE LINE OF SLOPE BETWEEN ADJACENT FOOTING EXCAVATIONS OR ALONG STEPPED FOOTINGS. FOR STEPPED FOOTINGS, USE STEPS NOT EXCEEDING 600 mm (2'-0") IN HEIGHT AND 1200 mm (4'-0") (MIN.) IN LENGTH.
- 1.6. SOIL BEARING CAPACITY SPECIFIED MUST BE VERIFIED IN WRITING BY THE SOIL ENGINEER PRIOR TO THE PLACING OF FOOTINGS AND ANY NON-CONFORMANCE WITH THE SPECIFIED MINIMUM CAPACITIES MUST BE IMMEDIATELY REPORTED TO THE STRUCTURAL ENGINEERS.
- 1.7. PLACE 150mm (6") CLEAR CRUSHED STONE OVER THE SUB_BASE, COMPACTED TO 100% SPMDD, WITH A MAXIMUM SURFACE VARIATION OF +/- 10MM.
- 1.8. BELOW SLABS ON GRADE BACKFILL USING NATIVE MATERIALS OR ENGINEERED FILL APPROVED BY THE GEOTECHNICAL CONSULTANT AND COMPACT IN MAX 150 MM LIFTS TO 98% SPMDD
- 1.9. BELOW EXTERIOR LANDSCAPED AREAS BACKFILL USING NATIVE MATERIALS OR FREE DRAINING MATERIALS AND COMPACT IN MAX 150 MM LIFTS TO 98% SPMDD.
- 1.10. PROVIDE TEMPORARY FROST PROTECTION, DURING CONSTRUCTION, FOR ALL FOUNDATIONS WHICH ARE NOT FOUNDED A MINIMUM OF 1200mm (4'-0") BELOW GRADE.
- 1.11. FOUND NEW FOOTINGS WHICH ARE LOCATED ADJACENT TO EXISTING FOOTINGS, AT THE SAME ELEVATION AS THE EXISTING FOOTINGS, UNLESS NOTED OTHERWISE.
- 1.12. INSULATION IS SHOWN WHERE REQUIRED FOR PROTECTION OF THE FOUNDATIONS FROM DAMAGE DUE TO FROST ACTION ONLY. REFER TO ARCHITECTURAL DRAWINGS FOR FOUNDATION INSULATION NOT SHOWN ON THE STRUCTURAL DRAWINGS.
- 1.13. DO NOT PLACE BACKFILL AGAINST WALLS RETAINING EARTH (OTHER THAN CANTILEVER RETAINING WALLS) UNTIL THE WALLS AND THE FLOOR CONSTRUCTION AT TOP AND BOTTOM OF THE WALLS HAVE BEEN CAST AND ATTAINED 100% OF THEIR DESIGN STRENGTH.
- 1.14. WHERE THE SLAB ON GRADE IS USED TO TIE THE TOP OF WALL RETAINING EARTH. THAT WALL SHALL BE ADEQUATELY BRACED UNTIL THE SLAB HAS BEEN CAST AND ATTAINED 100% OF ITS DESIGN STRENGTH
- 1,15, CARRY OUT BACKFILLING AGAINST FOUNDATION WALLS WHERE THERE IS GRADE ON BOTH SIDES IN SUCH A MANNER THAT THE LEVEL OF BACKFILLING ON ONE SIDE OF THE WALL IS NEVER MORE THAN 600 MM (2'-0") DIFFERENT FROM THE LEVEL ON THE OTHER SIDE OF THE WALL.
- 1.16. DO NOT COMPACT CLOSER THAN 1800 MM (6'-0") FROM WALLS WITH HEAVY EQUIPMENT. USE LIGHT HAND CONTROLLED EQUIPMENT WITHIN 1800 MM (6'-0") FROM WALLS.

SLAB-ON-GRADE

2.1. PLACE SLAB-ON-GRADE ON MATERIAL CAPABLE OF SUSTAINING A MINIMUM SLAB BEARING PRESSURE OF 25 KPa (500 psf) WITHOUT SETTLEMENT.

CONCRETE

- 3.1. THE CONTRACTOR SHALL ENSURE THAT REINFORCING STEEL IS ADEQUATELY BRACED AGAINST MOVEMENT DURING CONCRETE PLACING.
- 3.2. FABRICATE REINFORCEMENT IN ACCORDANCE WITH CAN/CSA A23.1 AND THE RSIC MANUAL OF STANDARD PRACTICE.
- 3.3. PERFORM FORMING OPERATIONS AND PLACE HARDWARE SO THAT FINISHED CONCRETE WILL BE WITHIN THE TOLERANCES SET OUT IN CAN/CSA-A23.1.
- 3.4. FOLLOW MANUFACTURER'S INSTRUCTIONS REGARDING INSTALLATION PROCEDURES AND MINIMUM EMBEDMENT OF ANCHORS.
- 3.5. GROUT BENEATH PLATES BEARING ON CONCRETE WITH AN APPROVED NON SHRINK
- FLOWABLE GROUT, CONFORM TO THE MANUFACTURER'S DIRECTIONS FOR MIXING AND PLACING GROUT. COMPLETELY FILL VOIDS BENEATH STEEL BASES ON CONCRETE WITH AN APPROVED NON-SHRINK 35 MPa (5ksi) GROUT.
- 3.6. ALL DOWELS SHALL HAVE MINIMUM EMBEDMENT EQUIVALENT TO THE STRAIGHT TENSION EMBEDMENT LENGTH OR 600 MM (2'-0"), WHICHEVER IS GREATER, UNLESS
- 3.7. PROVIDE DOWELS TO WALLS AND COLUMNS SIMILAR IN NUMBER, SIZE, AND SPACING TO THE VERTICAL STEEL IN THE WALL OR COLUMN ABOVE UNLESS NOTED
- 3.8. REINFORCEMENT IDENTIFIED AS 'CONTINUOUS' SHALL TERMINATE WITH STANDARD END HOOKS AND SHALL BE LAPPED WITH CLASS 'B' TENSION LAP SPLICES.
- 3.9. REINFORCEMENT LENGTHS NOTED IN TYPICAL DETAILS ARE MINIMUM LENGTHS UNLESS NOTED OTHERWISE.

3.10. CONSTRUCTION JOINTS:

- 3.10.1. HORIZONTAL CONSTRUCTION JOINTS SHALL NOT BE MADE IN BEAMS. UNLESS SHOWN OR APPROVED BY THE CONSULTANT.
- 3.10.2. HORIZONTAL CONSTRUCTION JOINTS IN WALLS SHALL BE ONLY MADE WHERE SHOWN ON THE DRAWINGS.
- 3.10.3. VERTICAL CONSTRUCTION JOINTS MAY BE MADE ONLY AT MIDSPAN OF BEAMS AND SLABS UNLESS NOTED OTHERWISE.
- 3.10.4. SUBMIT PROPOSED LOCATION OF ALL CONSTRUCTION JOINTS FOR REVIEW BY THE CONSULTANT.
- 3.11. OPENINGS. SLEEVES. EMBEDDED DUCTS:

- 3.11.1. NO SLEEVES SHALL BE PLACED VERTICALLY OR HORIZONTALLY THROUGH BEAMS UNLESS REVIEWED AND APPROVED BY THE CONSULTANT.
- 3.11.2. NO OPENINGS SHALL BE MADE IN FLAT PLATE OR FLAT SLAB UNLESS REVIEWED AND APPROVED BY THE CONSULTANT.

3.12. CONCRETE COVER:

- 3.12.1. COVER SHALL BE MEASURED FROM THE DEEPEST POINT TEXTURED CONCRETE SURFACE TO THE NEAREST DEFORMATION OF REINFORCEMENT. REINFORCEMENT INCLUDES TIES / STIRRUPS AND MAIN REINFORCEMENT
- 3.12.2. ALL CONCRETE CAST AGAINST EARTH IS TO HAVE 75 MM (3") COVER, UNO.
- 3.13. WHERE REINFORCEMENT IS NOT SPECIFICALLY IDENTIFIED ON THE DRAWINGS, PROVIDE 152x152 MW18.7xMW18.7 WELDED WIRE FABRIC AT IN SLABS ON GRADE, OR WALKS AND 51x51 MW5.6xMW5.6 TOPPINGS 60 MM (2½") IN THICKNESS OR GREATER.
- 3.14. PLACING CONCRETE 3.14.1. CONFORM TO REQUIREMENTS OF CSA A23.1. AND THE FOLLOWING:
- 3.14.1.1. IMMEDIATELY BEFORE PLACING CONCRETE, CLEAN FORMS AND REINFORCEMENT OF FOREIGN MATTER.
- 3.14.1.2. DO NOT USE CONCRETE MIXED MORE THAN TWO HOURS AFTER INTRODUCTION OF MIXING WATER.
- 3.14.1.3. DURING HOT WEATHER CONDITIONS, DO NOT USE CONCRETE MIXED MORE THAN ONE HOUR AFTER INTRODUCTION OF MIXING WATER.

3.14.1.4. ALLOW 24 HOURS MINIMUM AFTER PLACING CONCRETE IN COLUMNS, PIERS

OR WALLS BEFORE PLACING CONCRETE IN BEAMS OR SLABS SUPPORTED 3.14.2. PLACE CONCRETE ON AND STEEL DECK FLOORS IN A MANNER THAT AVOIDS PILING UP OF CONCRETE. DO NOT DROP CONCRETE DIRECTLY FROM BUCKETS,

BUT EMPLOY SUITABLE MEANS OF DISTRIBUTION. WET DOWN DECK DURING HOT

WEATHER PRIOR TO CONCRETING. 3.14.2.1. REMOVE CONCRETE SPILLED ONTO FORMS AROUND HOISTING EQUIPMENT

BEFORE DEPOSITING CONCRETE IN THESE AREAS. 3.15. CURING CONCRETE

3.15.1. CURE ALL CONCRETE IN ACCORDANCE WITH CSA A23.1, THE CONCRETE SUPPLIERS REQUIREMENTS AND AS SPECIFIED HEREIN

3.16. PROTECTION

- 3.16.1. CONFORM TO THE REQUIREMENTS OF CSA A23.1. PROTECT FRESHLY DEPOSITED CONCRETE FROM FREEZING, PREMATURE DRYING AND EXTREMES OF TEMPERATURE. MAINTAIN CONCRETE WITH MINIMAL MOISTURE LOSS AT A RELATIVELY CONSTANT TEMPERATURE FOR THE PERIOD OF TIME NECESSARY FOR THE HYDRATION OF THE CEMENT AND TO ACHIEVE THE SPECIFIED STRENGTH OF THE CONCRETE.
- 3.16.2. PROVIDE SUFFICIENT INSULATION, AND HEAT AS NECESSARY, TO PREVENT FREEZING OF FROST SUSCEPTIBLE SOIL WHICH LIES AGAINST STRUCTURAL ELEMENTS; IN PARTICULAR PROTECT SOIL BENEATH FOOTINGS AND BEHIND FOUNDATION WALLS UNTIL THE BUILDING IS COMPLETED.
- 3.16.3. CRACK REPAIR: PRIOR TO COMPLETION OF THE PROJECT AND IN ANY CASE NOT SOONER THAN 28 DAYS AFTER CONCRETE HAS BEEN PLACED, EXAMINE CONCRETE FLOOR SURFACES AND REPAIR ALL MAJOR CRACKS IN THEM. ROUT CRACKS OUT WITH MECHANICAL ROUTER TO 13 MM (1/2") SQUARE APPROXIMATE CROSS SECTION. THEN CLEAN AND FILL CRACKS IN SAME MANNER AS SAW CUTS IN SLAB ON GRADE.

POST-INSTALLED ANCHORS

4.1. EXCEPT WHERE INDICATED ON THE DRAWINGS, POST-INSTALLED ANCHORS SHALL CONSIST OF THE FOLLOWING ANCHOR TYPES AS PROVIDED BY HILTI (CANADA) CORPORATION.

4.1.1. ANCHORAGE TO CONCRETE

- ADHESIVE ANCHORS FOR CONCRETE USE:
- 4.1.1.0.1.1. HILTI HIT-HY 200 SAFE SET SYSTEM WITH HILTI HIT-Z ROD FOR FAST CURE APPLICATIONS.
- 4.1.1.0.1.2. HILTI HIT-HY 200 SAFE SET SYSTEM WITH HILTI HOLLOW DRILL BIT
- SYSTEM FOR FAST CURE APPLICATIONS. 4.1.1.0.1.3. HILTI HIT-RE 500-SD EPOXY ADHESIVE ANCHORING SYSTEM FOR
- 4.1.1.0.1.4. HILTI HIT-RE 500 EPOXY ADHESIVE ANCHORING SYSTEM FOR SLOW CURE APPLICATIONS.
- 4.1.1.0.1.5. STEEL ANCHOR ELEMENT SHALL BE HILTI HIS-N INTERNALLY THREADED INSERTS, HILTI HAS-E CONTINUOUSLY THREADED ROD. OR CONTINUOUSLY DEFORMED STEEL REBAR.
- 4.1.2. MEDIUM DUTY MECHANICAL ANCHORS FOR CONCRETE USE:
- 4.1.2.1. HILTI KWIK HUS EZ AND KWIK HUS EZ-I SCREW ANCHORS

SLOW CURE APPLICATIONS.

- HILTI KWIK BOLT-TZ EXPANSION ANCHORS.
- 4.1.2.3. HILTI KWIK BOLT 3 EXPANSION ANCHORS.
- 4.1.3. HEAVY DUTY MECHANICAL ANCHORS FOR CONCRETE USE 4.1.3.1. HILTI HDA UNDERCUT ANCHORS.
- 4.1.3.2. HILTI HSL-3 EXPANSION ANCHORS.
- 4.1.4. REBAR DOWELING INTO CONCRETE
- 4.1.4.1. ADHESIVE ANCHORS FOR CRACKED AND UNCRACKED CONCRETE USE:
- HILTI HIT-HY 200 SAFE SET SYSTEM WITH HILTI HOLLOW DRILL BIT SYSTEM WITH CONTINUOUSLY DEFORMED REBAR
- 4.1.4.1.2. HILTI HIT-RE 500-SD EPOXY ADHESIVE ANCHORING SYSTEM WITH CONTINUOUSLY DEFORMED REBAR.
- 4.1.4.1.3. HILTI HIT-RE 500 EPOXY ADHESIVE ANCHORING SYSTEM WITH CONTINUOUSLY DEFORMED REBAR.
- 4.2. ANCHOR CAPACITY USED IN DESIGN HAS BEEN BASED ON THE TECHNICAL DATA PUBLISHED BY HILTI. SUBSTITUTION REQUESTS FOR ALTERNATE ANCHORS MUST BE APPROVED IN WRITING BY THE CONSULTANT PRIOR TO USE. CONTRACTOR SHALL PROVIDE CALCULATIONS DEMONSTRATING THAT THE ALTERNATIVE ANCHOR IS CAPABLE OF ACHIEVING THE PERFORMANCE VALUES OF THE SPECIFIED PRODUCT.

- SUBSTITUTIONS WILL BE EVALUATED FOR COMPLIANCE WITH THE RELEVANT BUILDING CODE. ADHESIVE ANCHOR EVALUATION WILL ALSO CONSIDER CREEP, IN-SERVICE TEMPERATURE AND INSTALLATION TEMPERATURE.
- 4.3. INSTALL ANCHORS PER THE MANUFACTURER WRITTEN INSTRUCTIONS.
- 4.4. OVERHEAD ADHESIVE ANCHORS MUST BE INSTALLED USING THE HILTI PROFI SYSTEM.
- 4.5. THE CONTRACTOR SHALL ARRANGE AN ANCHOR MANUFACTURER'S REPRESENTATIVE TO PROVIDE ONSITE INSTALLATION TRAINING FOR ALL OF THEIR ANCHORING PRODUCTS SPECIFIED. THE CONSULTANT MUST RECEIVE DOCUMENTED CONFIRMATION THAT ALL OF THE CONTRACTOR'S PERSONNEL WHO INSTALL ANCHORS ARE TRAINED PRIOR TO THE COMMENCEMENT OF INSTALLING ANCHORS.
- 4.6. ANCHOR CAPACITY IS DEPENDANT UPON SPACING BETWEEN ADJACENT ANCHORS AND PROXIMITY OF ANCHORS TO EDGE OF CONCRETE. INSTALL ANCHORS IN STRICT ACCORDANCE WITH SPACING AND EDGE CLEARANCES INDICATED ON THE DRAWINGS.
- 4.7. EXISTING REINFORCEMENT IN THE CONCRETE STRUCTURE MAY CONFLICT WITH SPECIFIC ANCHOR LOCATIONS. UNLESS NOTED ON THE DRAWINGS THAT THE BARS CAN BE CUT, THE CONTRACTOR SHALL REVIEW THE EXISTING STRUCTURAL DRAWINGS AND SHALL UNDERTAKE TO LOCATE THE POSITION OF THE EXISTING REINFORCEMENT AT THE LOCATIONS OF THE CONCRETE ANCHORS, BY HILTI FERROSCAN, HILTI PS 1000, GPR, X-RAY, CHIPPING OR OTHER MEANS.

NOTIFICATION

5.1. PRIOR TO COMMENCING SIGNIFICANT SEGMENTS OF THE WORK, GIVE THE CONSULTANT AND INDEPENDENT INSPECTION AND TESTING COMPANIES APPROPRIATE NOTIFICATION (MINIMUM 24 HOURS) SO AS TO AFFORD THEM REASONABLE OPPORTUNITY TO REVIEW THE WORK. FAILURE TO MEET THIS REQUIREMENT MAY BE CAUSE FOR THE CONSULTANT TO CLASSIFY THE WORK AS DEFECTIVE.

DEFECTIVE MATERIALS AND WORK

- 6.1. WHERE EVIDENCE EXISTS THAT DEFECTIVE WORK HAS OCCURRED OR THAT WORK HAS BEEN CARRIED OUT INCORPORATING DEFECTIVE MATERIALS, THE CONSULTANT MAY HAVE TESTS, INSPECTIONS OR SURVEYS PERFORMED, ANALYTICAL CALCULATIONS OF STRUCTURAL STRENGTH MADE, AND THE LIKE, IN ORDER TO HELP DETERMINE WHETHER THE WORK MUST BE CORRECTED OR REPLACED. TESTS, INSPECTIONS SURVEYS, OR CALCULATIONS CARRIED OUT UNDER THESE CIRCUMSTANCES WILL BE MADE AT THE CONTRACTOR'S EXPENSE, REGARDLESS OF THEIR RESULTS, WHICH MAY BE SUCH THAT, IN THE CONSULTANT'S OPINION, THE WORK MAY BE ACCEPTABLE.
- 6.2. ALL TESTING SHALL BE CONDUCTED IN ACCORDANCE WITH THE REQUIREMENTS OF THI BUILDING CODE, EXCEPT WHERE THIS WOULD, IN THE CONSULTANT'S OPINION, CAUSE UNDUE DELAY OR GIVE RESULTS NOT REPRESENTATIVE OF THE REJECTED MATERIAL IN PLACE. IN THIS CASE, THE TESTS SHALL BE CONDUCTED IN ACCORDANCE WITH THE STANDARDS GIVEN BY THE CONSULTANT.
- 6.3. MATERIALS OR WORK, WHICH FAIL TO MEET SPECIFIED REQUIREMENTS, MAY BE REJECTED BY THE CONSULTANT WHENEVER FOUND AT ANY TIME PRIOR TO FINAL ACCEPTANCE OF THE WORK REGARDLESS OF PREVIOUS INSPECTION. IF REJECTED, DEFECTIVE MATERIALS OR WORKMANSHIP SHALL BE PROMPTLY REMOVED AND REPLACED OR REPAIRED TO THE SATISFACTION OF THE CONSULTANT, AT NO EXPENSE TO THE OWNER.



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